FIRE ALARM SYMBOL LIST

Connections / Equipment

Fire Alarm

JUNCTION BOX

FIRE/SMOKE DAMPER

FIRE/SMOKE DAMPER

MAGNETIC DOOR HOLDER

FIRE ALARM CONTROL PANEL

FIRE ALARM ANNUNCIATOR PANEL

BEAM TYPE SMOKE DETECTOR (BT =

ADDRESSABLE INPUT MODULE

ADDRESSABLE OUTPUT MODULE

ISOLATOR MODULE

SURGE SUPPRESSOR

PULL STATION

TRANSMITTER, BR = RECEIVER/REFLECTOR)

SPRINKLER FLOW SWITCH WITH INPUT MODULE

SPRINKLER TAMPER SWITCH WITH INPUT MODULE

HEAT DETECTOR (+F = FIXED, HIGH TEMP)

NOTIFICATION APPLIANCE CIRCUIT PANEL

FIRE ALARM COMMUNICATOR - CELLULAR

BEAM DETECTOR CONTROLLER WITH REMOTE TEST

	s a standard symbol list and not all items listed may be used.
4	<u>Abbreviations</u>
(E)	EXISTING
(N)	NEW
(X)	DEMOLISH
AFF	ABOVE FINISHED FLOOR
AHJ	AUTHORITY HAVING JURISDICTION
ASD	AIR SAMPLING DETECTOR
AS	AIR SAMPLING POINT
AUX	AUXILIARY
AWG BAS	AMERICAN WIRE GAUGE BUILDING AUTOMATION SYSTEM
BDC	BEAM DETECTOR CONTROLLER
С	CONDUIT
CLG	CEILING
CO	CARBON MONOXIDE
COORD	COORDINATE
dB	DECIBEL
DIA	DIAMETER
DIV	DIVISION
DTL	DETAIL
DWG	DRAWING
EA	EACH
EMT	ELECTRICAL METALLIC TUBING
EVAC	EMERGENCY VOICE/ALARM COMMUNICATION SYSTEM
FA	FIRE ALARM
FAA	FIRE ALARM ANNUNCIATOR
FAC	FIRE ALARM COMMUNICATOR
FACU	FIRE ALARM CONTROL UNIT
FACP	FIRE ALARM CONTROL PANEL
FATC	FIRE ALARM TERMINAL CABINET
FF	FINISHED FLOOR
FMC	FLEXIBLE METAL CONDUIT
FT	FOOT, FEET
GAP	GRAPHIC FIRE ALARM ANNUNCIATOR
HH	HANDHOLE
HT ID	HEIGHT IDENTIFICATION
IMC	INTERMEDIATE METAL CONDUIT
IN	INCH, INCHES
LED	LIGHT EMITTING DIODE
LOC	LOCAL OPERATING CONSOLE
LV	LOW VOLTAGE
mA	MILLIAMPERE
MIN	MINIMUM
MISC	MISCHELLANEOUS
N/A	NOT APPLICABLE
NAC	NOTIFICATION APPLINACE CIRCUIT
NTS	NOT TO SCALE
PG	PROTECTIVE GUARD
PNL	PANEL
PVC	POLYVINYL CHLORIDE
PWR	POWER
QTY	QUANTITY
REF	REFERENCE
RFI	REQUEST FOR INFORMATION
SHT	SHEET
SIM	SIMILAR
SLC	SIGNALING LINE CIRCUIT
STD	STANDARD
TBD	TO BE DETERMINED
TYP	TYPICAL
UG	UNDERGROUND
UL	UNDERWRITERS LABORATORIES
UPS	UNINTERUPTIBLE POWER SUPPLY
V	VOLT, VOLTS
VFD	VARIABLE FREQUENCY DRIVE
WG	WIREGUARD
WD	WEATHEDDDOOE

WEATHERPROOF

<u>General</u> DETAIL NUMBER AND SHEET LOCATION KEYED NOTE SECTION NUMBER AND SHEET LOCATION Raceways ———— CONDUIT ----- CONDUIT ROUTED BELOW FLOOR / GRADE CONDUIT ELLED DOWN CONDUIT ELLED UP CONDUIT/WIRING STUBBED OUT WITH END CAP OR INSULATED PLASTIC BUSHING SMOKE DETECTOR (SB = SOUNDER BASE, R = RELAY BASE) SPRINKLER POST INDICATOR VALVE WITH INPUT MODULE HORN/STROBE COMBINATION (# INDICATES MINIMUM CANDELA RATING, C = CEILING MOUNTED) STROBE, CEILING MOUNTED (# INDICATES MINIMUM CANDELA RATING) STROBE, WALL MOUNTED (# INDICATES MINIMUM CANDELA RATING)

FIRE ALARM SCOPE NOTES:

- A. PROVIDE A NEW ADDRESSABLE FIRE ALARM SYSTEM THROUGHOUT THE
- B. PROVIDE MANUAL PULL STATIONS AT ALL BUILDING EXITS.
- C. PROVIDE AREA DETECTION THROUGHOUT CORRIDORS, SPACES OPEN TO CORRIDORS, AND ADDITIONAL SPACES AS SHOWN ON DRAWINGS.
- D. PROVIDE AUDIBLE NOTIFICATION THROUGHOUT THE BUILDING.
- E. PROVIDE VISUAL NOTIFICATION IN ALL COMMON USE AND PUBLIC
- F. ELEVATOR IS OLD AND NOT CAPABLE OF RECALL OR ANY LIFE/SAFETY

FIRE ALARM INSTALLATION NOTES:

- A. 2ND AND 3RD FLOOR HARD CEILINGS HAVE ACCESS ABOVE VIA HATCHES LOCATED THROUGHOUT THE FLOORS.
- B. PREFERRED RACEWAY ROUTING SHOWN IN AESTHETICALLY SENSITIVE
- C. INSTALL CABLING CONCEALED IN WALLS AND ABOVE CEILINGS.
- D. FLUSH MOUNT DEVICES AND APPLIANCES.
- E. WHERE SURFACE MOUNT APPLIANCES OR DEVICES ARE REQUIRED, UTILIZE MATCHING MANUFACTURER BACKBOXES.
- F. WHERE SURFACE RACEWAY IS REQUIRED, PAINT TO MATCH EXISTING ADJACENT SURFACE.

FIRE ALARM DEMO NOTES:

- A. DEMOLISH THE EXISTING FIRE ALARM SYSTEM IN ITS ENTIRETY INCLUDING, BUT NOT LIMITED TO: EQUIPMENT, DEVICES, APPLIANCES, RACEWAY, AND CABLING.
- B. DEMO DRAWINGS ARE BASED ON CASUAL FIELD OBSERVATION AND MAY CONTAIN ERRORS. CONFIRM EXACT QUANTITY AND LOCATION OF EQUIPMENT, DEVICES, AND APPLIANCES ON SITE.
- C. PROVIDE BLANK FACEPLATES ON ALL EXISTING DEVICE AND APPLIANCE LOCATIONS. PAINT TO MATCH ADJACENT SURFACE.
- D. REMOVE EXISTING CONDUIT/RACEWAY ABOVE ACCESSIBLE CEILINGS AND OPEN TO STRUCTURE SPACES. CUT CONDUIT FLUSH WITH WALL, FLOOR, OR CEILING AND PATCH AND PAINT TO MATCH ADJACENT
- E. REMOVE ALL CABLING. EXISTING CABLING CAN NOT BE REUSED.

SHEET INDEX

FA0.0	COURTHOUSE - SYMBOL LIST AND GENERAL NOTES - FIRE AL
FAD2.0	COURTHOUSE - DEMO FIRST FLOOR PLAN - FIRE ALARM
FAD2.1	COURTHOUSE - DEMO SECOND FLOOR PLAN - FIRE ALARM
FAD2.2	COURTHOUSE - DEMO THIRD FLOOR PLAN - FIRE ALARM
FAD2.3	COURTHOUSE - DEMO FOURTH FLOOR PLAN - FIRE ALARM
FA2.0	COURTHOUSE - FIRST FLOOR PLAN - FIRE ALARM

COURTHOUSE - SECOND FLOOR PLAN - FIRE ALARM COURTHOUSE - THIRD FLOOR PLAN - FIRE ALARM COURTHOUSE - FOURTH FLOOR PLAN - FIRE ALARM

COURTHOUSE - DETAILS - FIRE ALARM

INTERFACE ENGINEERING

> **PROJECT** 2022-0463 CONTACT JAROD MYRICK

100 SW Main Street, Suite 1600 Portland, OR 97204 TEL 503.382.2266 www.interfaceengineering.com




SKAGIT COURTHOUSE -SYMBOL LIST AND GENERAL NOTES - FIRE ALARM DRAWN BY CHECKED BY

FA0.0

2022-0463

10/12/2022

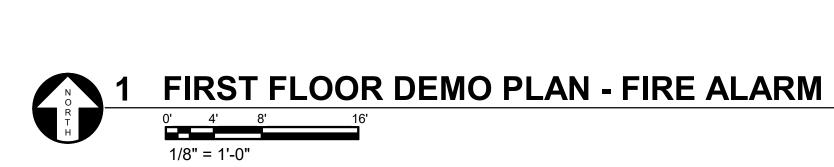



INTERFACE ENGINEERING

PROJECT 2022-0463 CONTACT JAROD MYRICK

100 SW Main Street, Suite 1600 Portland, OR 97204

TEL 503.382.2266
www.interfaceengineering.com

COURTHOUSE - DEMO FIRST FLOOR PLAN -FIRE ALARM

100% DD 100% CD

CHECKED BY

2022-0463 10/12/2022 SHEET NUMBER

FAD2.0





INTERFACE ENGINEERING

PROJECT 2022-0463 CONTACT JAROD MYRICK

100 SW Main Street, Suite 1600 Portland, OR 97204 TEL 503.382.2266 www.interfaceengineering.com

SHEET TITLE

COURTHOUSE - DEMO
SECOND FLOOR PLAN FIRE ALARM

REVISIONS

100% DD 08/10/2
100% CD 10/12/2

DRAWN BY

JBM

CHECKED BY

JOB NO.

2022-0463

DATE

10/12/2022

SHEET NUMBER

FAD2.1



SKAGIT COUNTY
ADMINISTRATION BUILDING
MOUNT VERNON, WA 98273

INTERFACE ENGINEERING

PROJECT 2022-0463 CONTACT JAROD MYRICK

100 SW Main Street, Suite 1600 Portland, OR 97204 TEL 503.382.2266 www.interfaceengineering.com

COURTHOUSE - DEMO THIRD FLOOR PLAN -FIRE ALARM

100% DD 100% CD

CHECKED BY


2022-0463

SHEET NUMBER

10/12/2022

FAD2.2



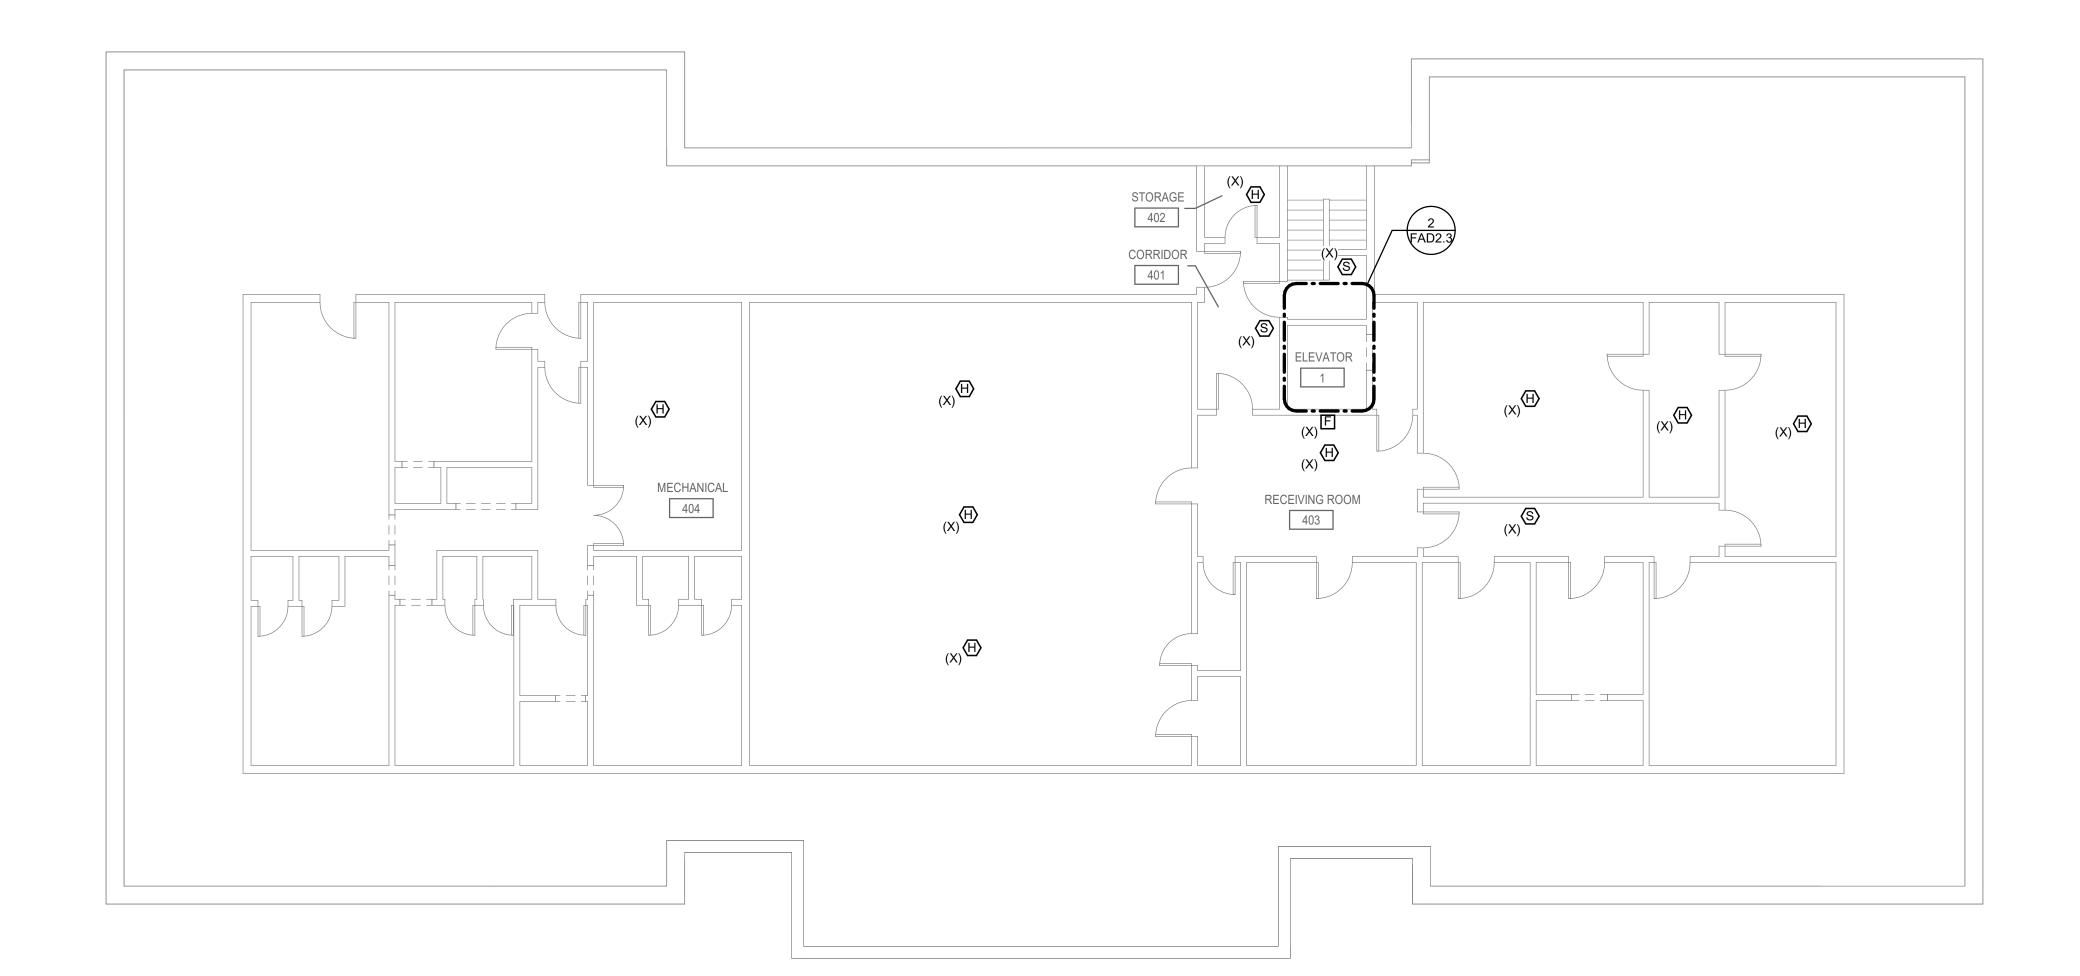





COUNTY

COURTHOUSE - DEMO FOURTH FLOOR PLAN -FIRE ALARM

REVISIO	NS		
	100% DD	30	3/10/2
	100% CD	10	0/12/2

CHECKED BY

2022-0463


10/12/2022

SHEET NUMBER FAD2.3

○ SHEET KEYNOTES


- 1. STUB CONDUIT ABOVE ACOUSTICAL TILE CEILING.

- PROVIDE 120V CIRCUIT FROM NEAREST AVAILABLE ELECTRICAL PANEL WITH SPARE CAPACITY.

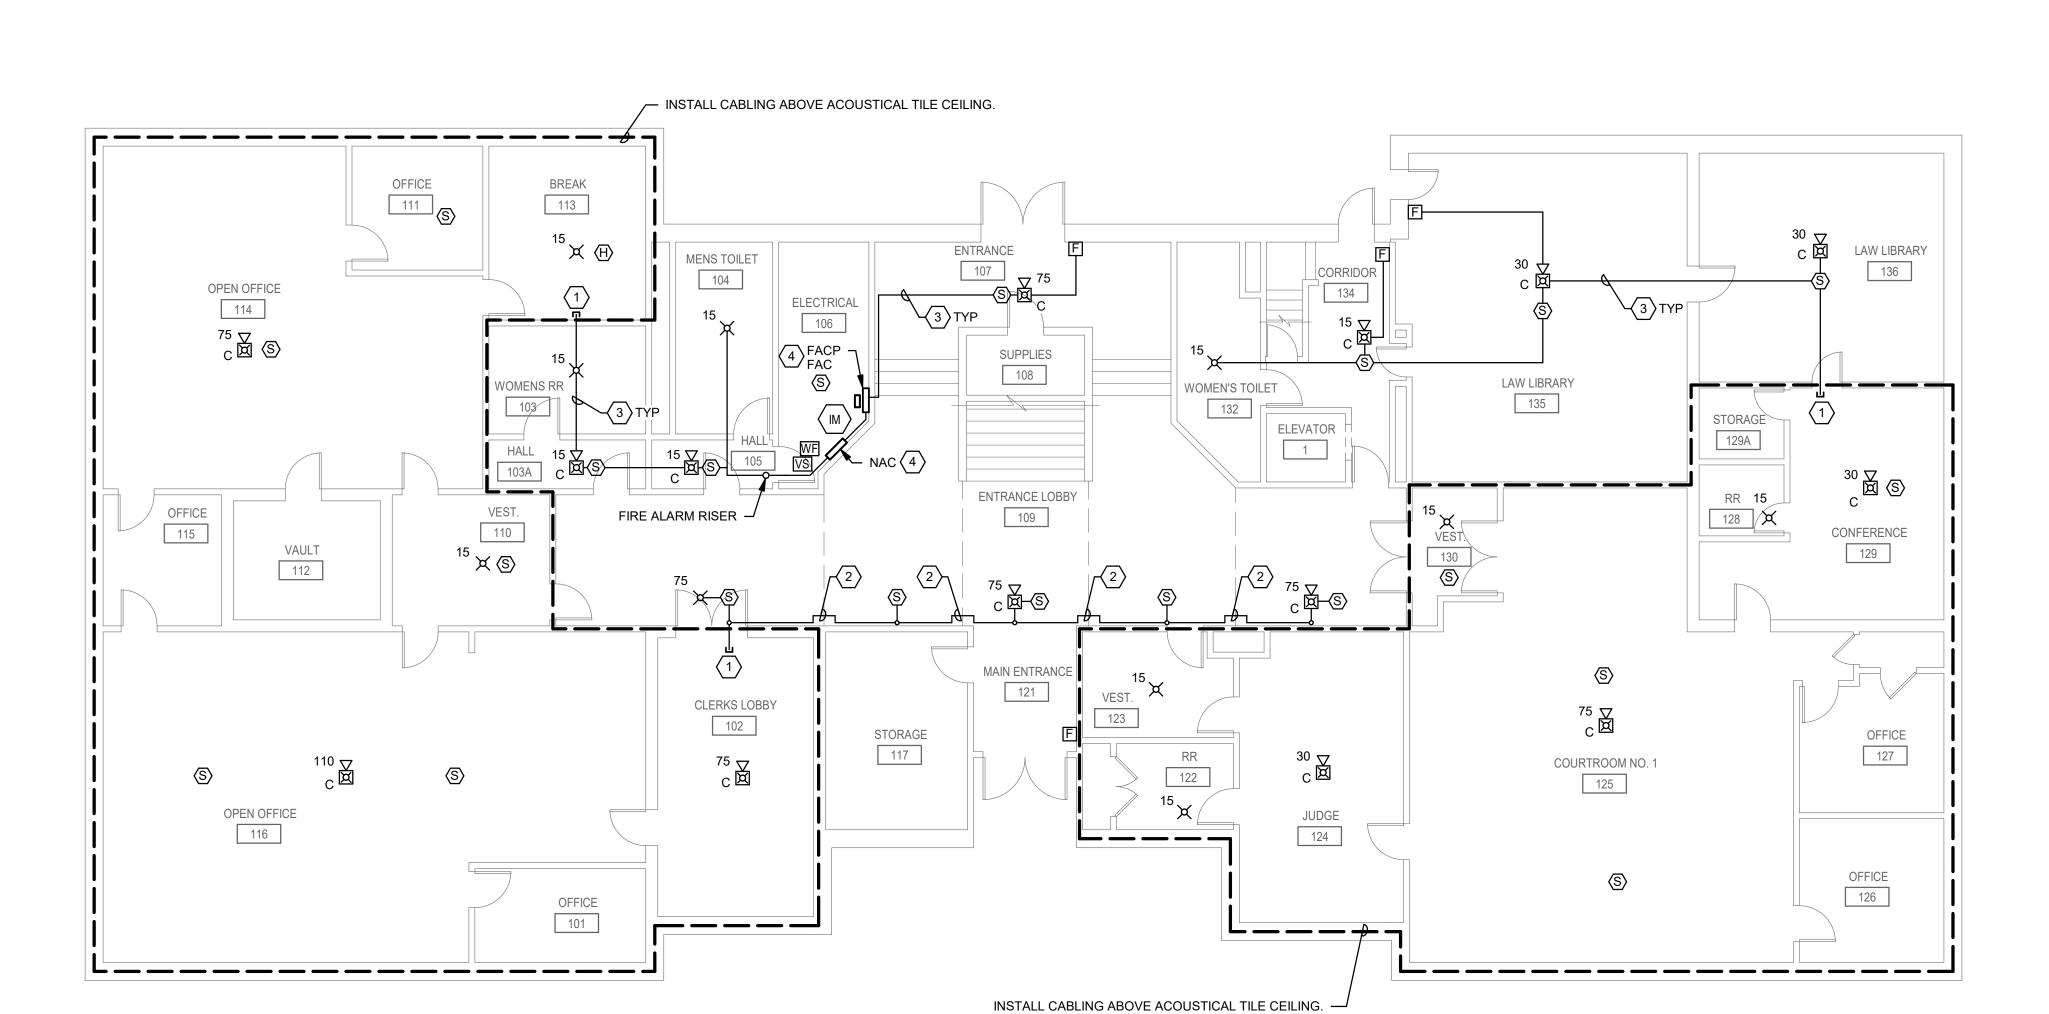



- SUGGESTED SURFACE RACEWAY ROUTING. ROUTE SURFACE RACEWAY HIGH ON WALL, BELOW BEAMS.
- SUGGESTED SURFACE RACEWAY ROUTING. COORDINATE EXACT ROUTING AND PENETRATIONS ON SITE.

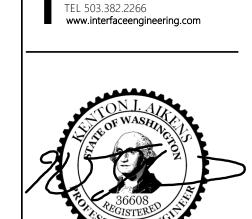

INTERFACE

ENGINEERING

PROJECT 2022-0463 CONTACT JAROD MYRICK

Portland, OR 97204

100 SW Main Street, Suite 1600


SKAGIT COURTHOUSE - FIRST FLOOR PLAN - FIRE ALARM

REVISIO	NS	
-	100% DD	08/10/22
-	100% CD	10/12/22
-		
-		
-		
DRAWN	BY	
IDM		

CHECKED BY

2022-0463 10/12/2022

SHEET NUMBER

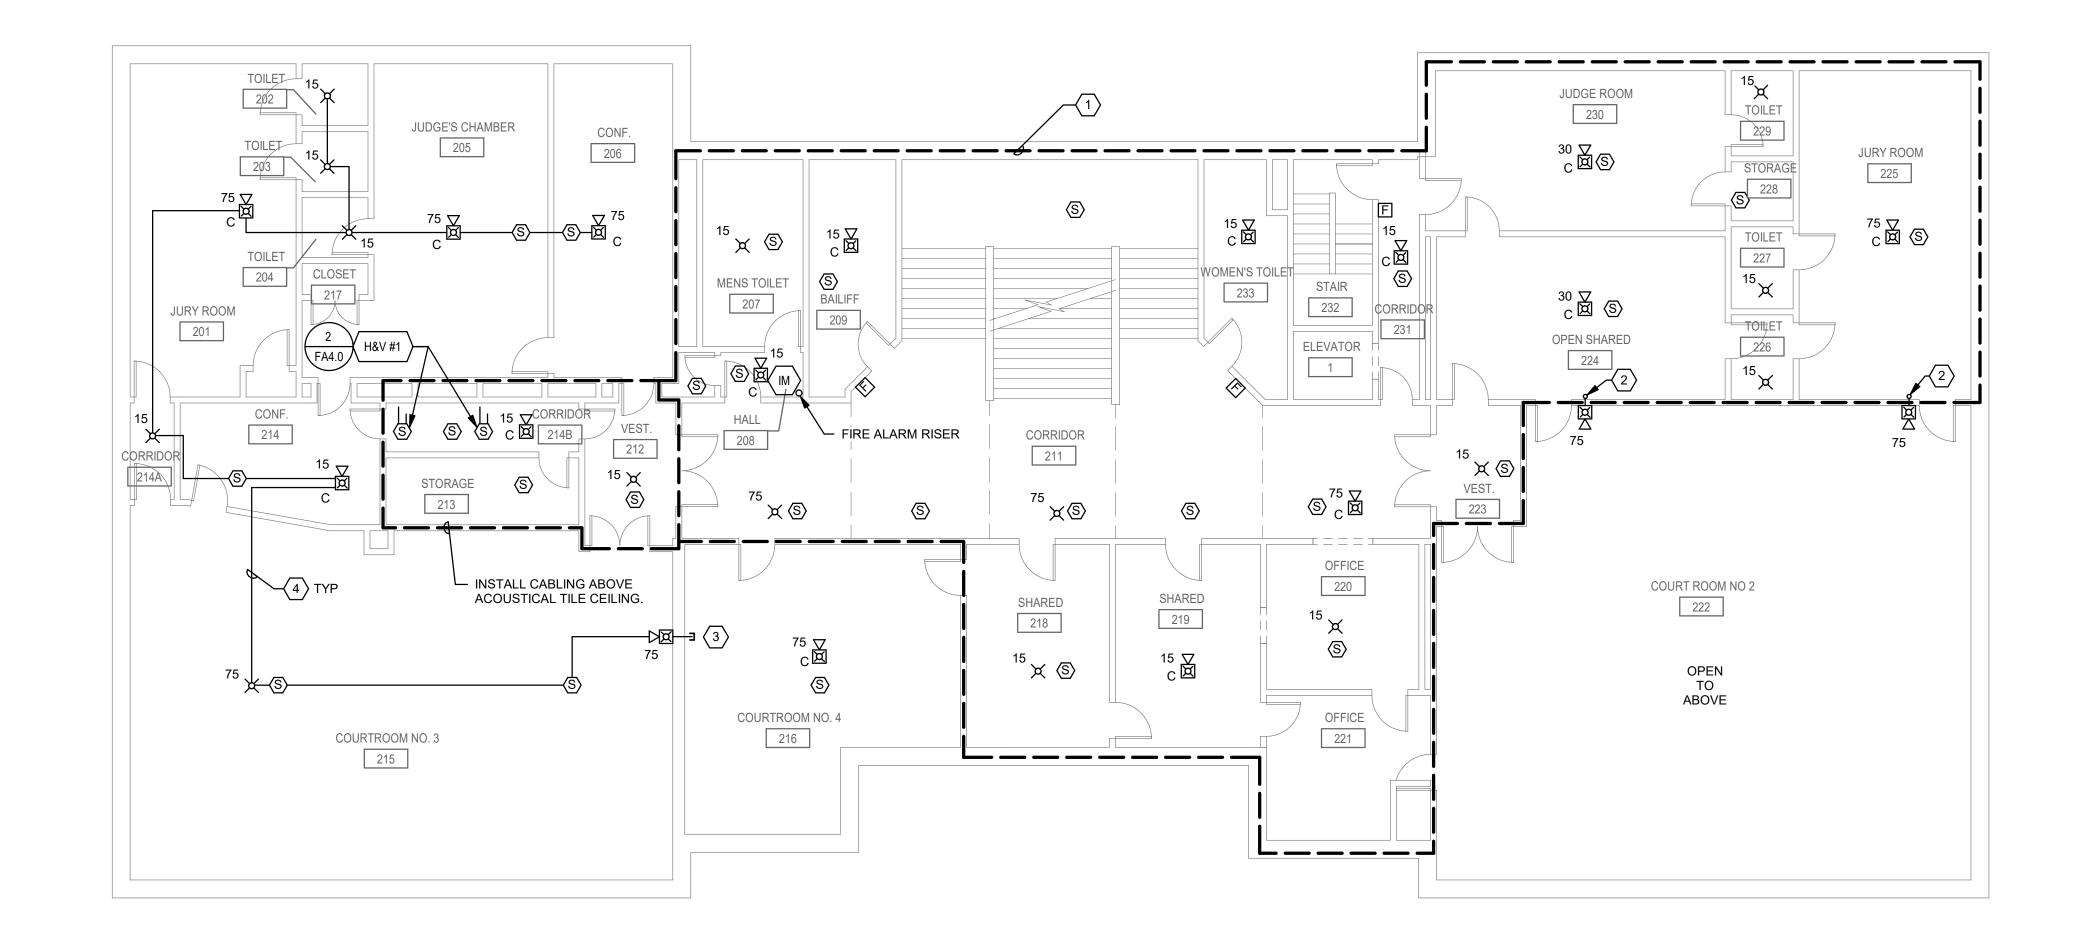



○ SHEET KEYNOTES

- 1. INSTALL CABLING IN CRAWL SPACE ABOVE CEILING.
- 2. ROUTE SURFACE RACEWAY DOWN WALL FROM CEILING CRAWL SPACE, PENETRATE THROUGH WALL, AND CONNECT IN TO BACK OF APPLIANCE.
- 3. STUB SURFACE RAEWAY ABOVE ACOUSTICAL TILE CEILING.
- 4. SUGGESTED SURFACE RACEWAY ROUTING.
 COORDINATE EXACT ROUTING AND PENETRATIONS ON SITE.



PROJECT 2022-0463 CONTACT JAROD MYRICK

100 SW Main Street, Suite 1600 Portland, OR 97204 TEL 503.382.2266 www.interfaceengineering.com



REGISTERED STONAL ENGINEER

STHOUSE FIRE ALARM SYSTEM UPGRAD

COURT 205 W KINCAL MOUNT VERN


SHEET TITLE

COURTHOUSE SECOND FLOOR PLAN FIRE ALARM

REVISIONS

	100% 00	00/10
	100% CD	10/12
DRAWN	BY	
	JBM	
CHECKE	D BY	
	JJR	
JOB NO.		
	2022-0463	
DATE		
	10/12/2022	
SHEET	NUMBER	

FA2.1

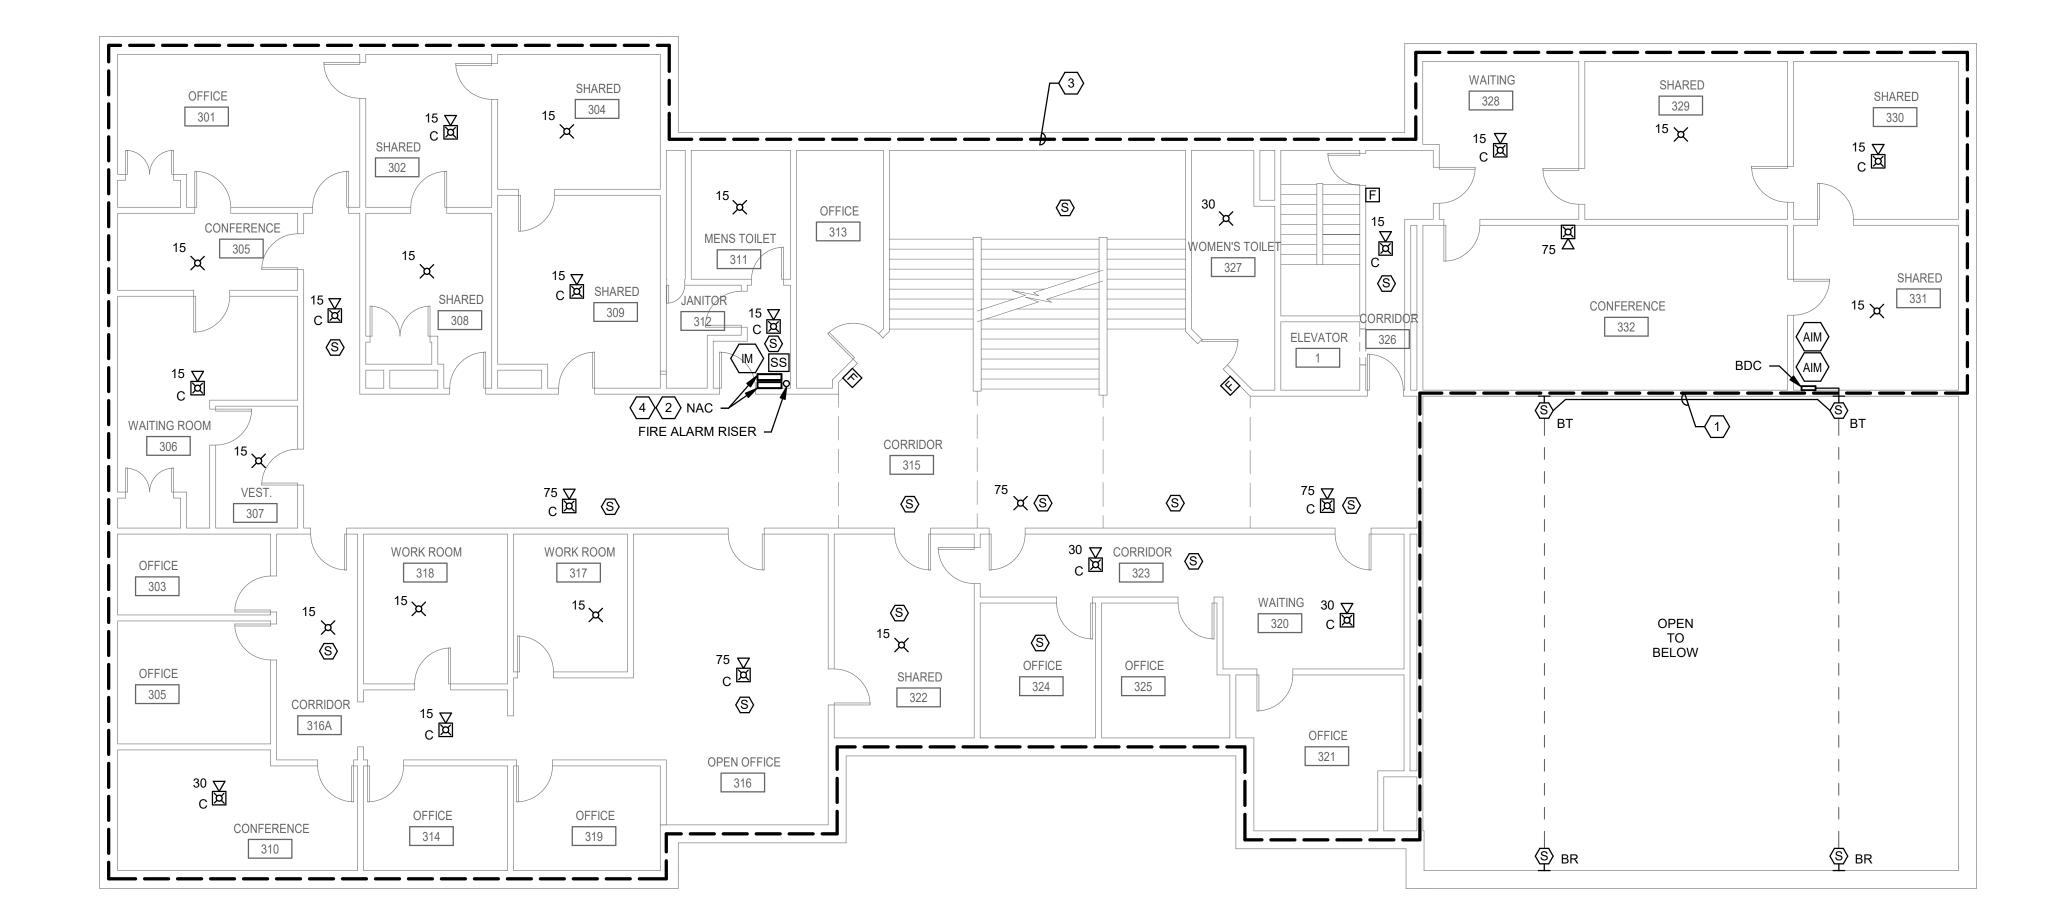



○ SHEET KEYNOTES

- SUGGESTED SURFACE RACEWAY ROUTING. COORDINATE EXACT ROUTING AND PENETRATIONS ON SITE.
- 2. PROVIDE QUANTITY OF POWER SUPPLIES REQUIRED FOR COMPLETE SYSTEM OPERATION.
- 3. INSTALL CABLING IN CRAWL SPACE ABOVE CEILING
- 4. PROVIDE 120V CIRCUIT FROM NEAREST AVAILABLE ELECTRICAL PANEL WITH SPARE CAPACITY.

AND/OR ACOUSTICAL TILE CEILINGS.

E N G I N E



PROJECT 2022-0463 CONTACT JAROD MYRICK

100 SW Main Street, Suite 1600 Portland, OR 97204 TEL 503.382.2266 www.interfaceengineering.com



IOUSE FIRE ALARM SYSTEM UPGRADE

SKAGIT

COURTHOUS

COURTHOUS

SOS W KINCAID ST

MOUNT VERNON, W

REVISIONS

100% DD 08/10

100% CD 10/12

100% CD 10/12/2

JBM CHECKED BY

JJR JOB NO.

2022-0463

DATE 10/12/2022

10/1
SHEET NUMBER

FA2.2

- ABANDONED AREA IS BEING DEMOLISHED IN A SEPARATE PROJECT AND CONVERTED TO 3RD FLOOR ROOF. NO NEW WORK THIS AREA.
- ROUTE NEW CIRCUIT IN CONDUIT AROUND EXISTING STRUCTURE. PROVIDE WEATHERPROOF CONDUIT AND WIRING.
- 3. CONDUIT RISER DOWN TO 3RD FLOOR.




PROJECT 2022-0463 CONTACT JAROD MYRICK 100 SW Main Street, Suite 1600 Portland, OR 97204 TEL 503.382.2266 www.interfaceengineering.com







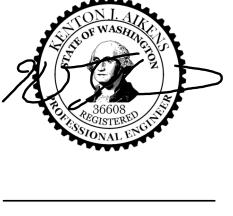

COURTHOUSE -FOURTH FLOOR PLAN -FIRE ALARM

REVISI	ONS		
	100% DD		08/1
	100% CD		10/1
DRAWI	J RV		
DIVAWI		ЗМ	
	J.	JIVI	
CHECK			
	J.	JR	
JOB NO).		

2022-0463

10/12/2022


SHEET NUMBER FA2.3

2 ELEV. MACH. RM - FIRE ALARM

0' 4' 8' 16'

1/8" = 1'-0"


ELEV. MACH. RM 405

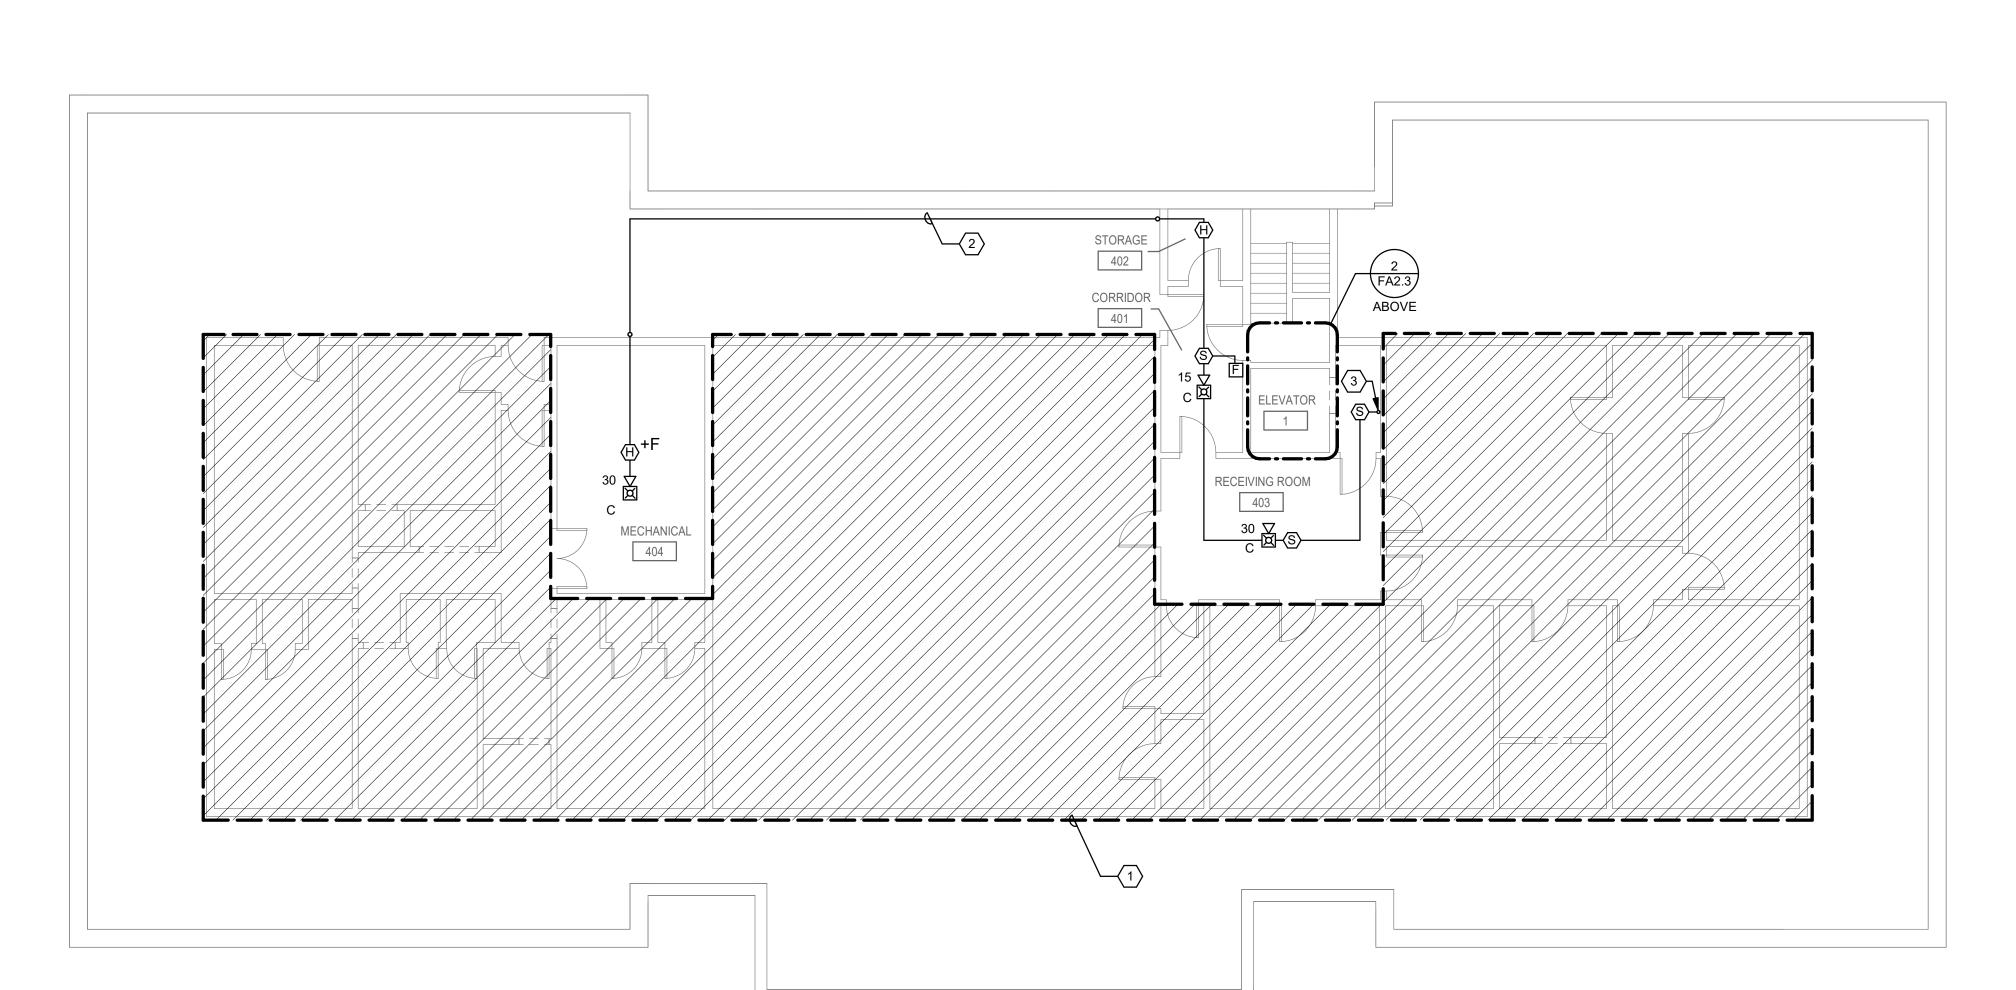

A. RISER IS DIAGRAMMATICAL AND ONLY SHOWS TYPICAL LAYOUT OF APPLIANCES, DEVICES AND EQUIPMENT. THE CONTRACTOR IS RESPONSIBLE FOR THE DESIGN AND INSTALLATION OF THE SYSTEM IN ACCORDANCE WITH THE SPECIFICATIONS AND ADOPTED CODES AND STANDARDS.


○ <u>DETAIL KEYNOTES</u>

1. 120VAC PRIMARY POWER SOURCE SHALL BE A MECHANICALLY
PROTECTED BRANCH CIRCUIT. THE CIRCUIT DISCONNECTING MEANS
SHALL HAVE A RED MARKING, AND IDENTIFIED AS "FIRE ALARM
CIRCUIT"

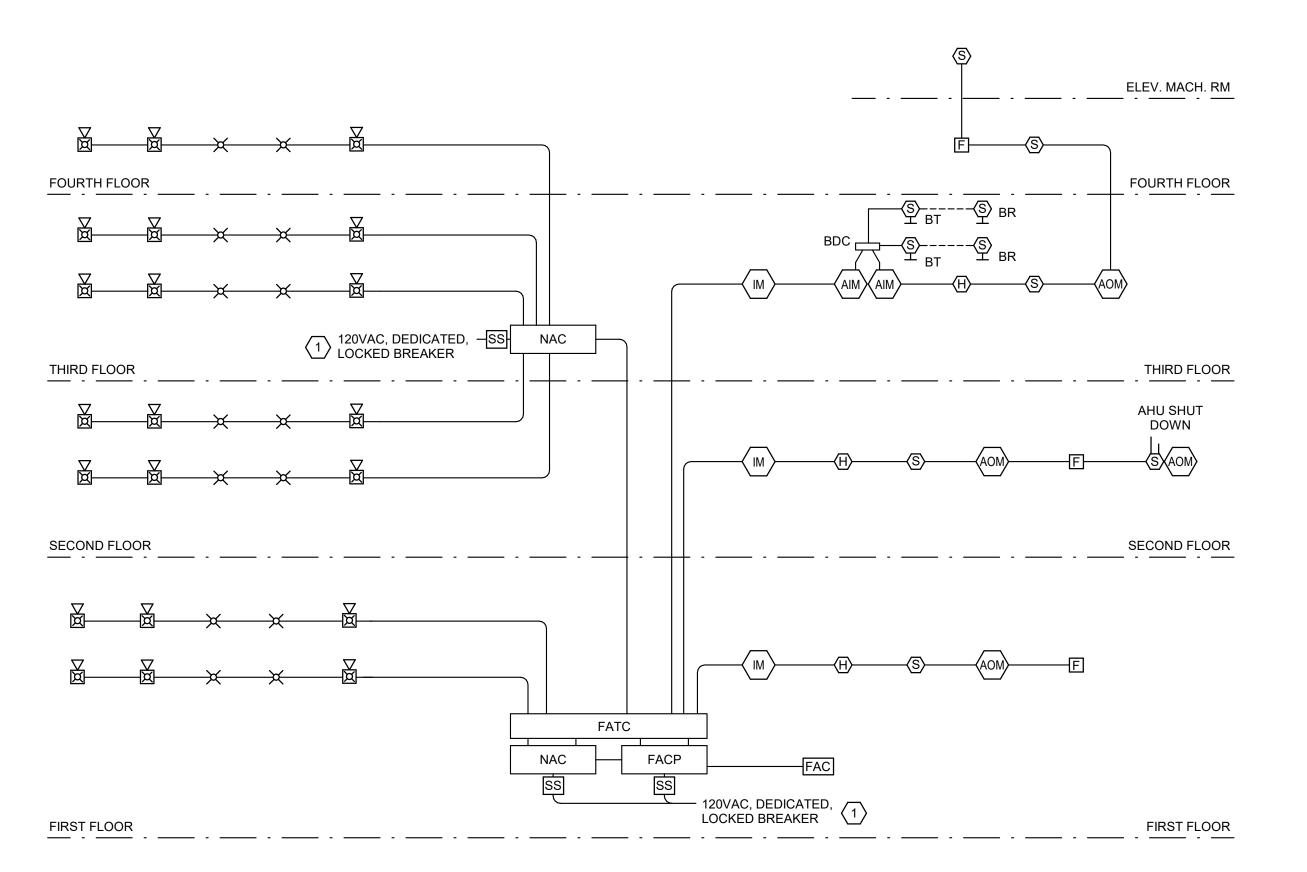

3 TYPICAL RISER DIAGRAM - FIRE ALARM


NO SCALE

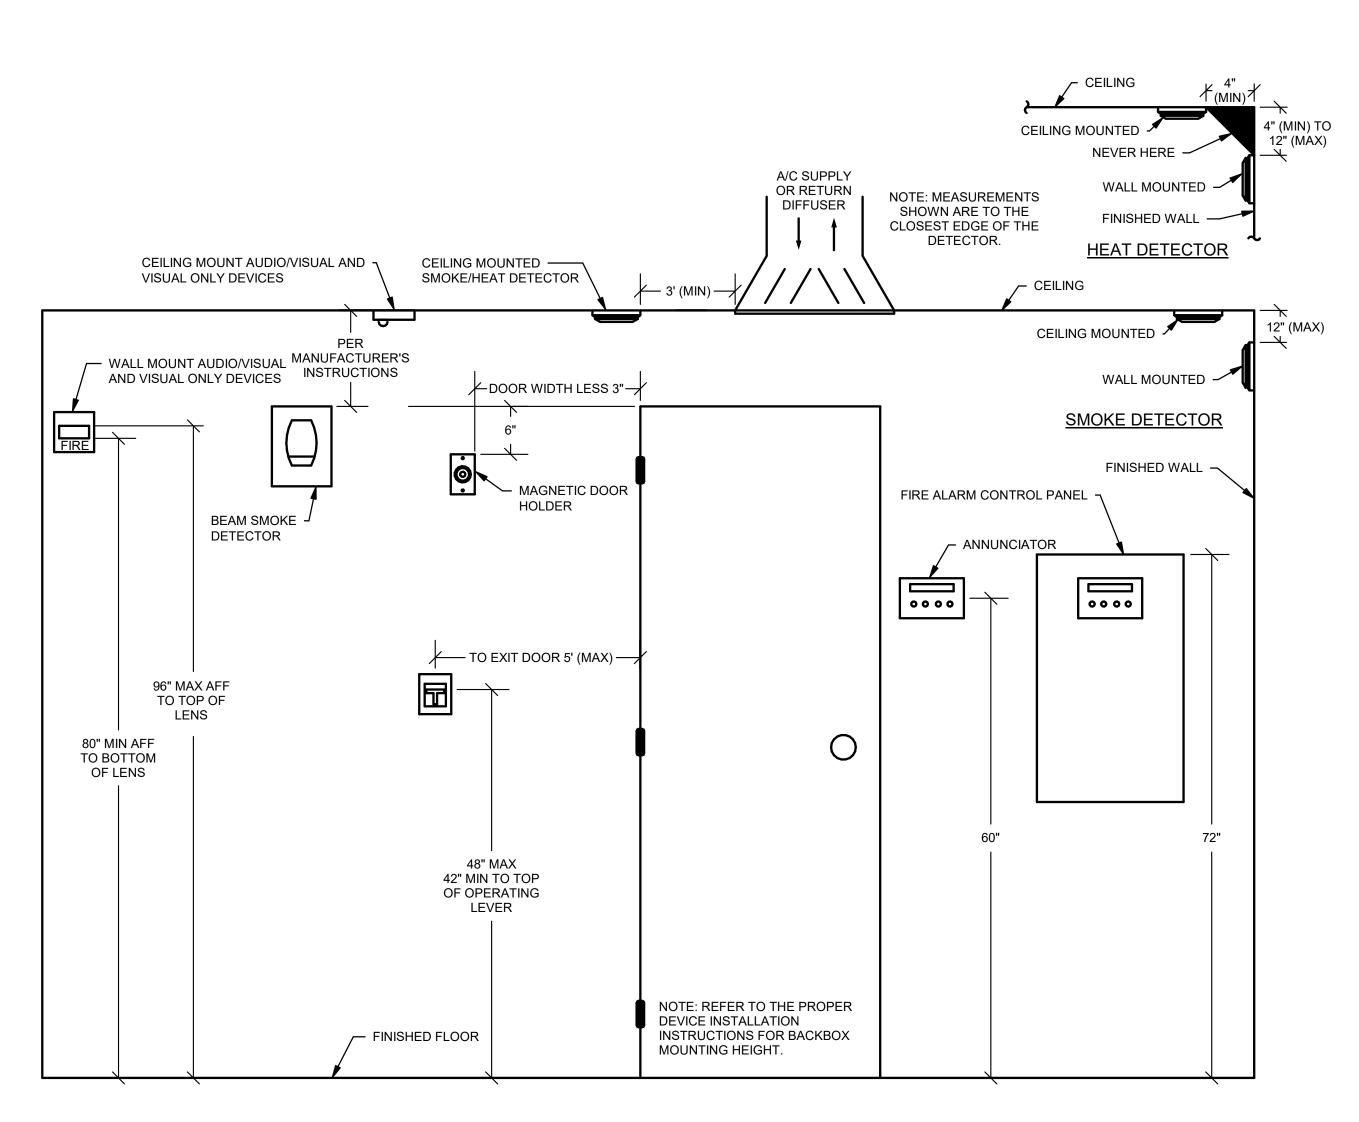

1 DEVICE MOUNTING HEIGHTS

NO SCALE

- 1 AIR HANDLING UNIT (AHU) STARTER/VFD.
- FIRE ALARM ADDRESSABLE RELAY. CONNECT TO EMERGENCY STOP INPUT ON FAN CONTROLLER. PROGRAM TO STOP FAN ON ACTIVATION OF ASSOCIATED SMOKE DETECTION. PROVIDE RELAY FOR EACH FAN CONTROLLER.
- 3 FIRE ALARM ADDRESSABLE DUCT SMOKE DETECTOR.

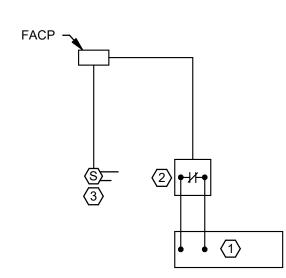

2 HVAC FAN SHUT DOWN DIAGRAM

NO SCALE

SKAGIT COUNTY ADMINISTRATION BUILDING FIRE ALAF

MINISTRATION BUILDING FIR

INTERFACE

ENGINEERING

PROJECT 2022-0463
CONTACT JAROD MYRICK

Portland, OR 97204

TEL 503.382.2266 www.interfaceengineering.com

100 SW Main Street, Suite 1600

SHEET TITLE
COURTHOUSE -

DETAILS - FIRE ALARM

REVISIONS

100% DD 08/10/2

100% CD 10/12/2

JBM
CHECKED BY
JJR

2022-0463

DATE 10/12/2022

FA4.0