

ABBREVIATIONS			
ABBREVIATION	DESCRIPTION	ABBREVIATION	DESCRIPTION
AAV	AUTOMATIC AIR VENT	DAMP	DAMPER
ABV	ABOVE	DB	DRY BULB
AC	AIR CONDITIONING UNIT	DC	DUST COLLECTOR
AD	ACCESS DOOR	DET	DETAIL
AFF	ABOVE FINISHED FLOOR	DIA	DIAMETER
AFS	AIR FLOW STATION	DIAG	DIAGRAM
AHU	AIR HANDLING UNIT	DIFF	DIFFERENTIAL
AL	ACOUSTICAL LINING	DISCH	DISCHARGE
ALT	ALTERNATE	DIV	DIVISION
ALUM	ALUMINUM	DN	DOWN
AP	ACCESS PANEL	DWG	DRAWING
APPROX	APPROXIMATE	DX	DIRECT EXPANSION
AVG	AVERAGE	EA	EACH
BB	ELECTRIC BASEBOARD HEATER	EAT	ENTERING AIR TEMPERATURE
B	BOILER	EC	ELECTRICAL CONTRACTOR
BBD	BACK DRAFT DAMPER	EDH	ELECTRIC DUCT HEATER
BFC	BELOW FINISHED CEILING	EF	EXHAUST FAN
BFP	BACKFLOW PREVENTOR	EFF	EFFICIENCY
BG	BLAST GATE	EJ	EXPANSION JOINT
BHP	BREAK HORSEPOWER	EL	ELEVATION
BLDG	BUILDING	ELEC	ELECTRIC
BLW	BELOW	ENT	ENTERING
BOB	BOTTOM OF BEAM	EQUIP	EQUIPMENT
BOD	BOTTOM OF DUCT	EQUIV	EQUIVALENT
BOP	BOTTOM OF PIPE	ERC	ENERGY RECLAIM COIL
BSMT	BASEMENT	ERV	ENERGY RECOVERY UNIT
BTU	BRITISH THERMAL UNIT	ESP	EXTERNAL STATIC PRESSURE
BV	BUTTERFLY VALVE	ET	EXPANSION TANK
C	CHILLER	EUH	ELECTRIC UNIT HEATER
CAP	CAPACITY	EWT	ENTERING WATER TEMPERATURE
CBV	CIRCUIT BALANCING VALVE	EXIST	EXISTING
CC	COOLING COIL	EXPA	EXPANSION
CD	CEILING DIFFUSER	EXT	EXTERNAL
CF	CEILING FAN	F	FILTER
CFH	CUBIC FEET PER HOUR	FA	FREE AREA
CFM	CUBIC FEET PER MINUTE	FC	FLEXIBLE CONNECTION
CFU	CHEMICAL FEED UNIT	FCU	FAN COIL UNIT
CHWP	CHILLED WATER PUMP	FCV	FLOW CONTROL VALVE
CHWR	CHILLED WATER RETURN	FD	FLOOR DRAIN
CHWS	CHILLED WATER SUPPLY	F/D	FIRE DAMPER
CI	CAST IRON	FIN	FINISHED
CL	CENTERLINE	FL	FLANGED
CLG	CEILING	FLA	FULL LOAD AMPS
CMU	CONCRETE MANSORY UNIT	FLEX	FLEXIBLE
CO	CLEANOUT	FLR	FLOOR
COL	COLUMN	FM	FLOW METER
COMP	COMPRESSOR	FOP	FUEL OIL PUMP
CONC	CONCRETE	FP	FIRE PROTECTION
COND	CONDENSATE	FPM	FEET PER MINUTE
CONN	CONNECTION	FPS	FEET PER SECOND
CONT	CONTINUATION	FRICT	FRICTION
CONTR	CONTRACTOR	F/S/D	COMBINATION FIRE SMOKE DAMPER
CP	CONDENSATE PUMP	FT	FEET
CT	COOLING TOWER	FTR	FINNED TUBE RADIATOR
CTF	COOLING TOWER FILTER	FV	FACE VELOCITY
CWR	CONDENSER WATER RETURN	GA	GUAGE
CWS	CONDENSER WATER SUPPLY	GAL	GALLONS
CU	CONDENSING UNIT	GALV	GALVANIZED
CUH	CABINET UNIT HEATER	GC	GENERAL CONTRACTOR
CV	AUTOMATIC CONTROL VALVE	GPH	GALLONS PER HOUR
CVB	CONSTANT VOLUME BOX	GPM	GALLONS PER MINUTE
CWP	CONDENSER WATER PUMP	GRD	GRILLE/REGISTER/DIFFUSER
		GRS/LB	GRAINS PER POUND

NOTE:
ALL ABBREVIATIONS AND SYMBOLS MAY NOT APPEAR ON THE DRAWINGS FOR THIS PROJECT.

GENERAL

(E)	EXISTING EQUIPMENT TO REMAIN
R	EXISTING EQUIPMENT TO BE REMOVED
ER	EXISTING EQUIPMENT TO BE RELOCATED
RE	RELOCATED EXISTING EQUIPMENT
○	ROUND
○	OVAL
□	SQUARE FEET

HVAC REFERENCE SYMBOLS

	EQUIPMENT IDENTITY (SEE EQUIPMENT ABBREVIATION LIST AND SCHEDULES)
	EQUIPMENT NUMBER
	INDICATES DETAIL, PLAN, SECTION, AND/OR DIAGRAM (APPLIES ONLY WHERE INDICATED ON DRAWINGS)
	INDICATES DRAWING ON WHICH DETAIL APPEARS
	INDICATES TYPICAL DETAIL (APPLIES TO ALL CONTRACT DRAWINGS)
	INDICATES DRAWING ON WHICH DETAIL APPEARS
	INDICATES SECTION NUMBER
	INDICATES ON WHICH DRAWING SECTION APPEARS
	INDICATES REVISION & NUMBER
	LOCATION POINT FOR COORDINATION BETWEEN FLOOR PLANS & PIPING DIAGRAMS (NUMBER)
	CONNECT NEW TO EXISTING
	TERMINATION POINT OF DEMOLITION
	CONNECT TO MANUFACTURER'S PREPIPED CONNECTION
	POINT OF BEAM PENETRATION
	PREPURCHASED EQUIPMENT
	KEYED NOTE NUMBER

DUCTWORK SYMBOLS


DOUBLE LINE	SINGLE LINE

DRAWING INDEX

M0.0	LEGENDS AND ABBREVIATIONS
M0.1	SPECIFICATIONS
M0.2	SPECIFICATIONS
M0.3	SCHEDULES
M0.4	SCHEDULES
M1.0	MECHANICAL DEMOLITION PLAN
M1.1	MECHANICAL PLAN
M1.2	MEZZANINE MECHANICAL PLAN
M1.3	STORAGE MECHANICAL PLAN
M3.0	DETAILS
M3.1	DETAILS
M3.2	DETAILS
M4.0	CONTROLS

MECHANICAL SYMBOLS

	MOTORIZED DAMPER		AIR DEVICE TO BE REMOVED
	BACKDRAFT DAMPER		SUPPLY AIR
	UNDERCUT DOOR		RETURN OR EXHAUST AIR
	DOOR LOWER (FREE AREA REQUIRED INDICATED IN SQUARE FEET)		OUTSIDE AIR
	COIL		FIRE DAMPER
	LOUVER		SMOKE DETECTOR
	TRANSFER		THERMOSTAT WITH HUMIDISTAT
			THERMOSTAT
			HUMIDISTAT

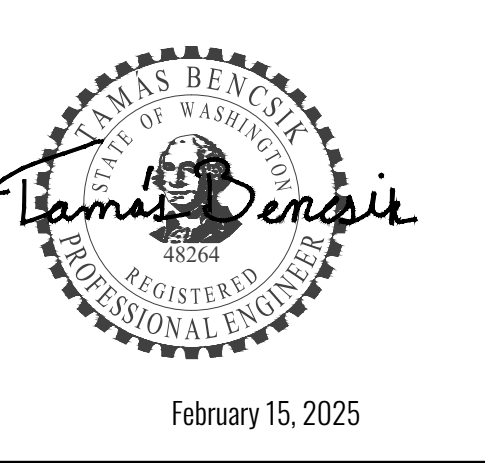

**SKAGIT COUNTY
CONCRETE COMMUNITY
CENTER**

REVISIONS	
stage:	BID SET
client:	CARLETTI ARCHITECTS
project:	CONCRETE COMMUNITY CENTER 45821 RAILROAD AVE CONCRETE, WASHINGTON
drawn by:	NH
original sheet size:	24x36
revision:	None
date:	2025.02.18
scale:	

LEGENDS AND ABBREVIATIONS

sheet. **M0.0**

ENERGY RECOVERY UNIT SCHEDULE table with columns: EQUIP ID, SHEET LOCATION, AREA SERVED, BASIS OF DESIGN, SUPPLY, EXHAUST, ELECTRICAL, SENSIBLE EFFECTIVENESS, WINTER LAT, FILTERS, OPERATING, NOTES.

VARIABLE REFRIGERANT VOLUME - INDOOR UNIT SCHEDULE table with columns: TAG, SHEET LOCATION, AREA SERVED, BASIS OF DESIGN (DAKIN), NOMINAL TONNAGE, TYPE, COOLING CAPACITY, HEATING CAPACITY, REFRIGERANT CHARGE, CONNECTION RATIO, ELECTRICAL, DIMENSIONS, WEIGHT, NOTES, ACCESSORIES.

VARIABLE REFRIGERANT VOLUME - AIR-COOLED CONDENSING UNIT SCHEDULE table with columns: TAG, SHEET LOCATION, BASIS OF DESIGN (DAKIN), NOMINAL TONNAGE, DESCRIPTION, COOLING CAPACITY, HEATING CAPACITY, REFRIGERANT CHARGE, CONNECTION RATIO, ELECTRICAL, DIMENSIONS, EFFICIENCY, NOTES, ACCESSORIES.

EXHAUST FAN SCHEDULE table with columns: EQUIP ID, SHEET LOCATION, AREA SERVED, LOCATION, CFM, ESP, FAN RPM, HP, BHP, VOLTS, PH, FLA, FAN TYPE, DRIVE TYPE, BASIS OF DESIGN, OPERATING WEIGHT, NOTES.

MAKEUP AIR UNIT SCHEDULE table with columns: EQUIP ID, SHEET LOCATION, AREA SERVED, BASIS OF DESIGN, FANS SUPPLY, ELECTRICAL, HEATER, FILTERS, WEIGHT, CONTROL, NOTES.

CEILING FAN SCHEDULE table with columns: EQUIP ID, SHEET LOCATION, AREA SERVED, LOCATION, BASIS OF DESIGN, FAN, ELECTRICAL, OPERATING WEIGHT, NOTES.

ELECTRICAL WALL HEATER SCHEDULE table with columns: EQUIP ID, SHEET LOCATION, AREA SERVED, BASIS OF DESIGN, ELECTRICAL, OPERATING WEIGHT, NOTES.

KITCHEN HOOD SCHEDULE table with columns: EQUIP ID, SHEET LOCATION, AREA SERVED, LOCATION, CFM, CFM/FT, BASIS OF DESIGN, LENGTH, TYPE, OPERATING WEIGHT, NOTES.


FILTER HOUSING SCHEDULE table with columns: DAKIN FAN COIL MODEL, MAX AIRFLOW CFM, FILTER, HOUSING DIMENSIONS, FILTER QUANTITY, FILTER SIZE HxWxD, REMARKS.

SUPPLY, RETURN, EXHAUST AND RELIEF AIR DUCTWORK INSULATION PER 2021 WSEC TABLE C403.10.1.2 table with columns: DUCT SYSTEM, DUCT LOCATION AND USE, CLIMATE ZONE, MINIMUM INSTALLED DUCT INSULATION R-VALUE, NOTES.

LOW PRESSURE DUCT SIZING REFERENCE TABLE table with columns: ROUND DUCT, DUCT LOSS/100 FT, CFM MIN, CFM MAX.

GRILLE, RESISTER, DIFFUSER SCHEDULE table with columns: EQUIP ID, SERVICE, BASIS OF DESIGN, MODEL, DEFLECTION, SPACING, MOUNTING.

OUTSIDE AIR DUCTWORK INSULATION PER 2021 WSEC TABLE C403.10.1.1 table with columns: DUCT SYSTEM, DUCT LOCATION AND USE, CLIMATE ZONE, AIRFLOW, MINIMUM INSTALLED DUCT INSULATION R-VALUE, NOTES.

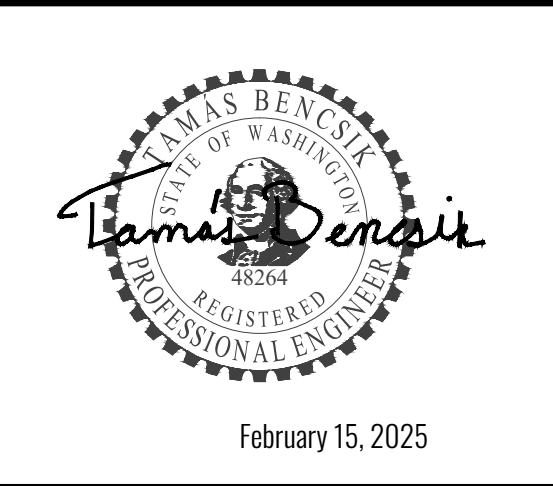

February 15, 2025



SKAGIT COUNTY CONCRETE COMMUNITY CENTER

REVISIONS

Project details table: stage: BID SET, client: CARLETTI ARCHITECTS, project: CONCRETE COMMUNITY CENTER, 45821 RAILROAD AVE, CONCRETE, WASHINGTON, drawn by: NH, original sheet size: 24x36, revision: None, date: 2025.02.18, scale:

SCHEDULES

sheet.

CONDENSOR SCHEDULE										
EQUIP ID	QUANTITY	MANUFACTURER	MODEL	DESCRIPTION	ELECTRICAL				CONDITIONS	EVAPORATOR
					VOLTAGE-PHASE	RLA	MOPO	MCA		
Refrigeration Condensing Unit for Holding Freezer	1	HTPG - RUSSELL DOE	RFO230L4SDANT	NEXT-GEN MINI-CON CONDENSING UNIT: LOW TEMPERATURE: SCROLL COMPRESSOR	208-230/1	12.4359	25	17.5	BTUH: 6370 Room Temp: -10°F Ambient: 95°F	Manufacturer: HTPG - RUSSELL DOE Electric: defrost LOW-PROFILE WITH DUAL SPEED EC MOTOR: coil • Model: RL6E662ADARE • Extras: None • Electrical: 208-230/1/60, Fan amps: 1, Defrost amps 9.8
Condensing Unit for Holding	1	HTPG - RUSSELL DOE	RFO060M4SDANT	NEXT-GEN MINI-CON CONDENSING UNIT: MEDIUM TEMPERATURE: SCROLL COMPRESSOR	208-230/1	5.4	15	15	BTUH: 6580 Room Temp: 35°F Ambient: 95°F	Manufacturer: HTPG - RUSSELL DOE • Description: Air defrost LOW-PROFILE WITH DUAL SPEED EC MOTOR coil • Model: RL6A662ADARE • Extras: None • Electrical: 115/1/60, Fan amps 0.8, Defrost amps N/A



JTK ENGINEERING
HVAC | PLUMBING | ENERGY
WWW.JTKENG.COM



February 15, 2025



CARLETTI ARCHITECTS P.S.
ARCHITECTURE, PLANNING, INTERIOR DESIGN
116 EAST FR STREET
SUITE A
MOUNT VERNON, WA 98273
Phone: (360) 434-6384
Fax: (360) 424-3726



**SKAGIT COUNTY
CONCRETE COMMUNITY
CENTER**

REVISIONS

stage: **BID SET**

client: **CARLETTI ARCHITECTS**

project: **CONCRETE COMMUNITY CENTER
45821 RAILROAD AVE
CONCRETE,
WASHINGTON**

drawn by: **NH**

original sheet size: **24x36**

revision: **None**

date: **2025.02.18**

scale:


SCHEDULES

sheet.

M0.4



JTK ENGINEERING
HVAC | PLUMBING | ENERGY
WWW.JTKENG.COM

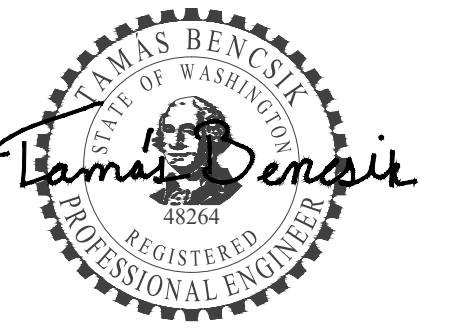

February 15, 2025



CARLETTI ARCHITECTS P.S.
116 EAST FIR STREET
SUITE A
MOUNT VERNON, WA 98273
Phone: (360) 434-0384
Fax: (360) 424-3726



**SKAGIT COUNTY
CONCRETE COMMUNITY
CENTER**

REVISIONS

stage: **BID SET**

client: **CARLETTI ARCHITECTS**

project: **CONCRETE COMMUNITY CENTER
45821 RAILROAD AVE
CONCRETE,
WASHINGTON**

drawn by: **NH**

original sheet size: **24x36**

revision: **None**


date: **2025.02.18**

scale:

**MECHANICAL
DEMOLITION PLAN**

sheet: **M1.0**

- KEYED NOTES:**
- 1 DEMOLISH EXISTING KITCHEN HOOD AND ACCESSORIES.
 - 2 DEMOLISH EXISTING KITCHEN HOOD EXHAUST FAN, DUCTWORK AND ACCESSORIES. EXISTING CURB TO REMAIN.
 - 3 DEMOLISH EXISTING KITCHEN HOOD FIRE SUPPRESSION SYSTEM.
 - 4 DEMOLISH EXISTING ELECTRIC HEATER.
 - 5 DEMOLISH EXISTING PROPANE FURNACE IN ATTIC.
 - 6 DEMOLISH EXISTING DUCTWORK.
 - 7 DEMOLISH EXISTING THERMOSTAT, WIRING, CONDUIT AND ACCESSORIES.
 - 8 DEMOLISH EXISTING EXHAUST FAN, DUCT AND ACCESSORIES.
 - 9 DEMOLISH EXISTING CEILING FAN AND ACCESSORIES.
 - 10 EXISTING MAKEUP AIR DUCTWORK TO BE DEMOLISHED.
 - 11 EXISTING LOUVER TO BE BLANKED OFF WITH 2" RIGID INSULATION WITH SHEETMETAL BACKING.
 - 12 DEMOLISH EXISTING RETURN GRILLE AND DUCT.
 - 13 DEMOLISH EXISTING THERMOSTAT, WIRING, CONDUIT AND ACCESSORIES.
 - 14 DEMOLISH DUCTWORK. CEILING DIFFUSER TO REMAIN.
 - 15 EXISTING TO REMAIN.

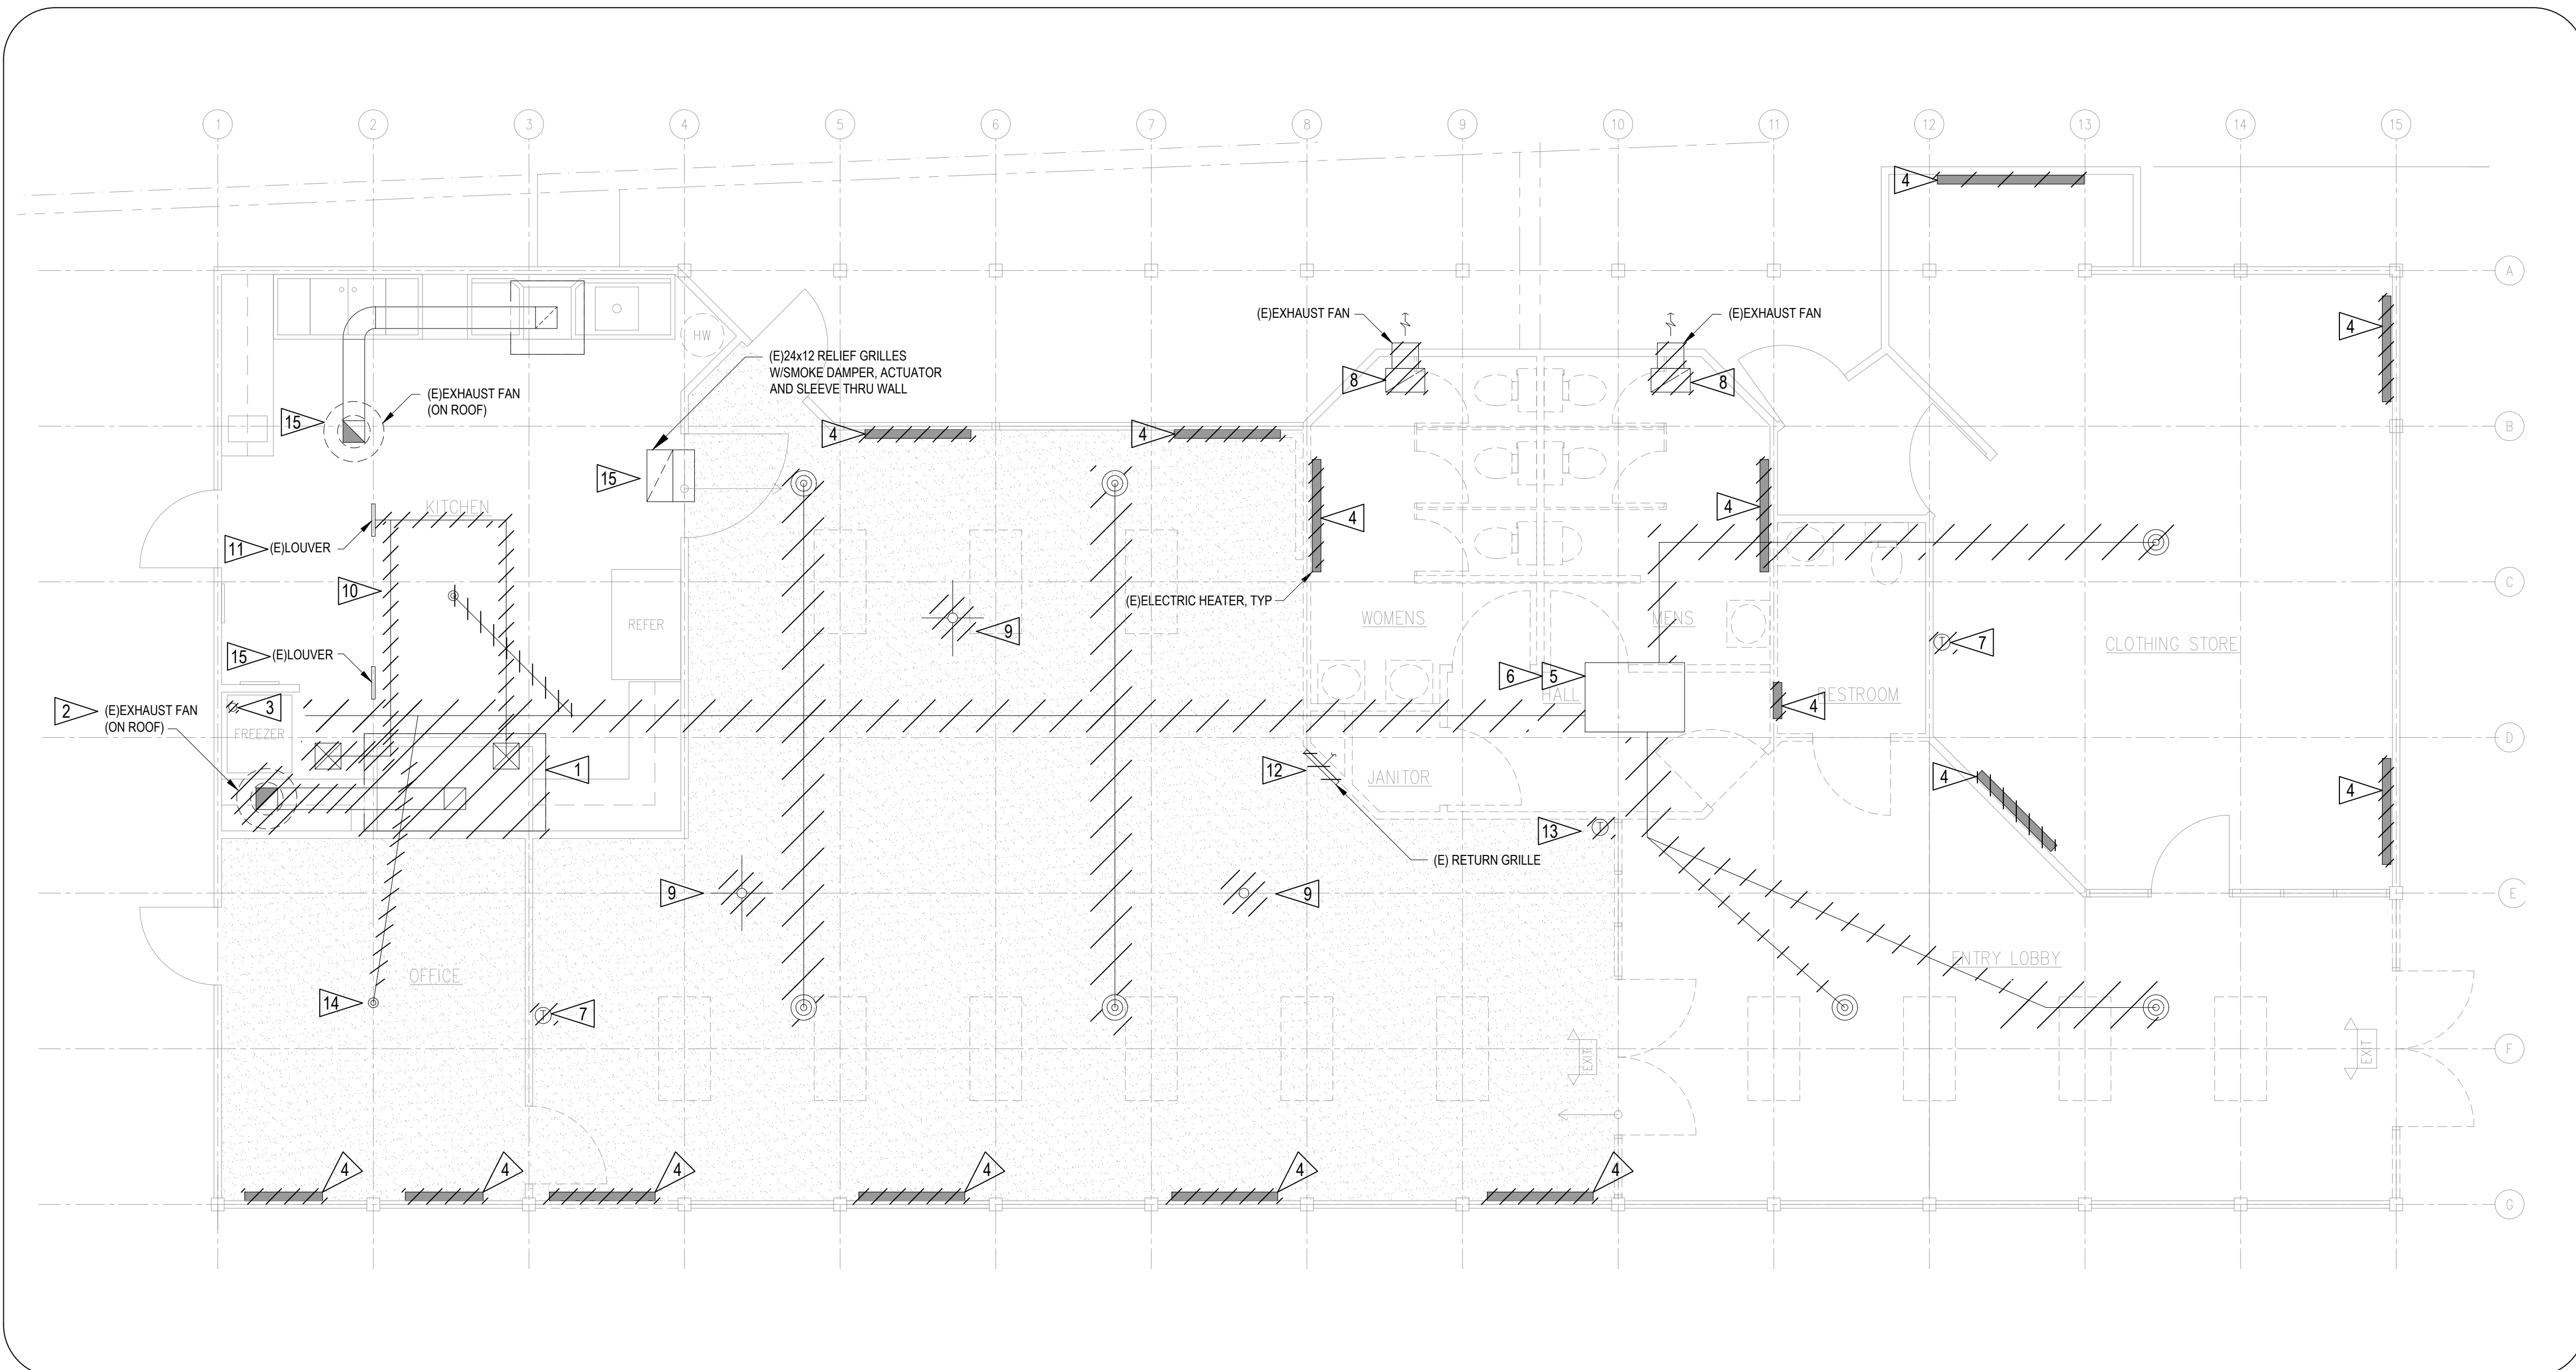

1 MECHANICAL DEMOLITION PLAN
M1.0 SCALE: 1/4" = 1'-0"



JTK ENGINEERING
HVAC | PLUMBING | ENERGY
WWW.JTKENG.COM



February 15, 2025



CARLETTI ARCHITECTS P.S.
ARCHITECTS, PLANNING, INTERIOR DESIGN
116 EAST FIR STREET
SUITE A
MOUNT VERNON, WA 98273
Phone: (360) 434-5344
Fax: (360) 424-3725



**SKAGIT COUNTY
CONCRETE COMMUNITY
CENTER**

REVISIONS

NO.	DESCRIPTION
stage:	BID SET
client:	CARLETTI ARCHITECTS
project:	CONCRETE COMMUNITY CENTER 45821 RAILROAD AVE CONCRETE, WASHINGTON
drawn by:	NH
original sheet size:	24x36
revision:	None
date:	2025.02.18
scale:	

**MECHANICAL
PLAN**

sheet.


M1.1

GENERAL NOTES:


- Maintain minimum 10 FT separation of outside air intakes from exhaust air outlets:
 - Lot lines (on street or public way, distance shall be measured from opposite side of street or public way)
 - Streets
 - Alleys
 - Parking lots
 - Loading docks
- Exhaust air outlets, vents, flues shall maintain a minimum of:
 - 3 FT from operable openings (includes doors and windows)
 - 3 FT from property lines
 - 10 FT from outside air intakes
- Contractor shall coordinate location of all access doors and panels for equipment and accessories.
- Field coordinate condensate drain piping routing to approved discharge location
- Provide volume damper for each grille register and diffuser duct branch

KEYED NOTES:

- Field coordinate drain routing.
- Mount high in space. Coordinate with trades.
- See M1.2 for continuation.
- Provide dryer exhaust with wall cap discharge. Locate min. 3' above top of door.
- Maintain distances from walls per manufacturers instructions.
- Provide piping via weather tight wall penetration from ground mounted equipment.
- Provide 4" housekeeping pad.
- Refer to ceiling fan details for installation requirements.
- Provide motorized damper at building envelope.
- Install ceiling fan above plane of light as not to create strobe affect.
- Locate mezzanine above kitchen.
- Coordinate framing for cassette fan coil units.
- Coordinate framing through existing walls for new ducts.
- Coordinate framing through existing walls for new ducts.

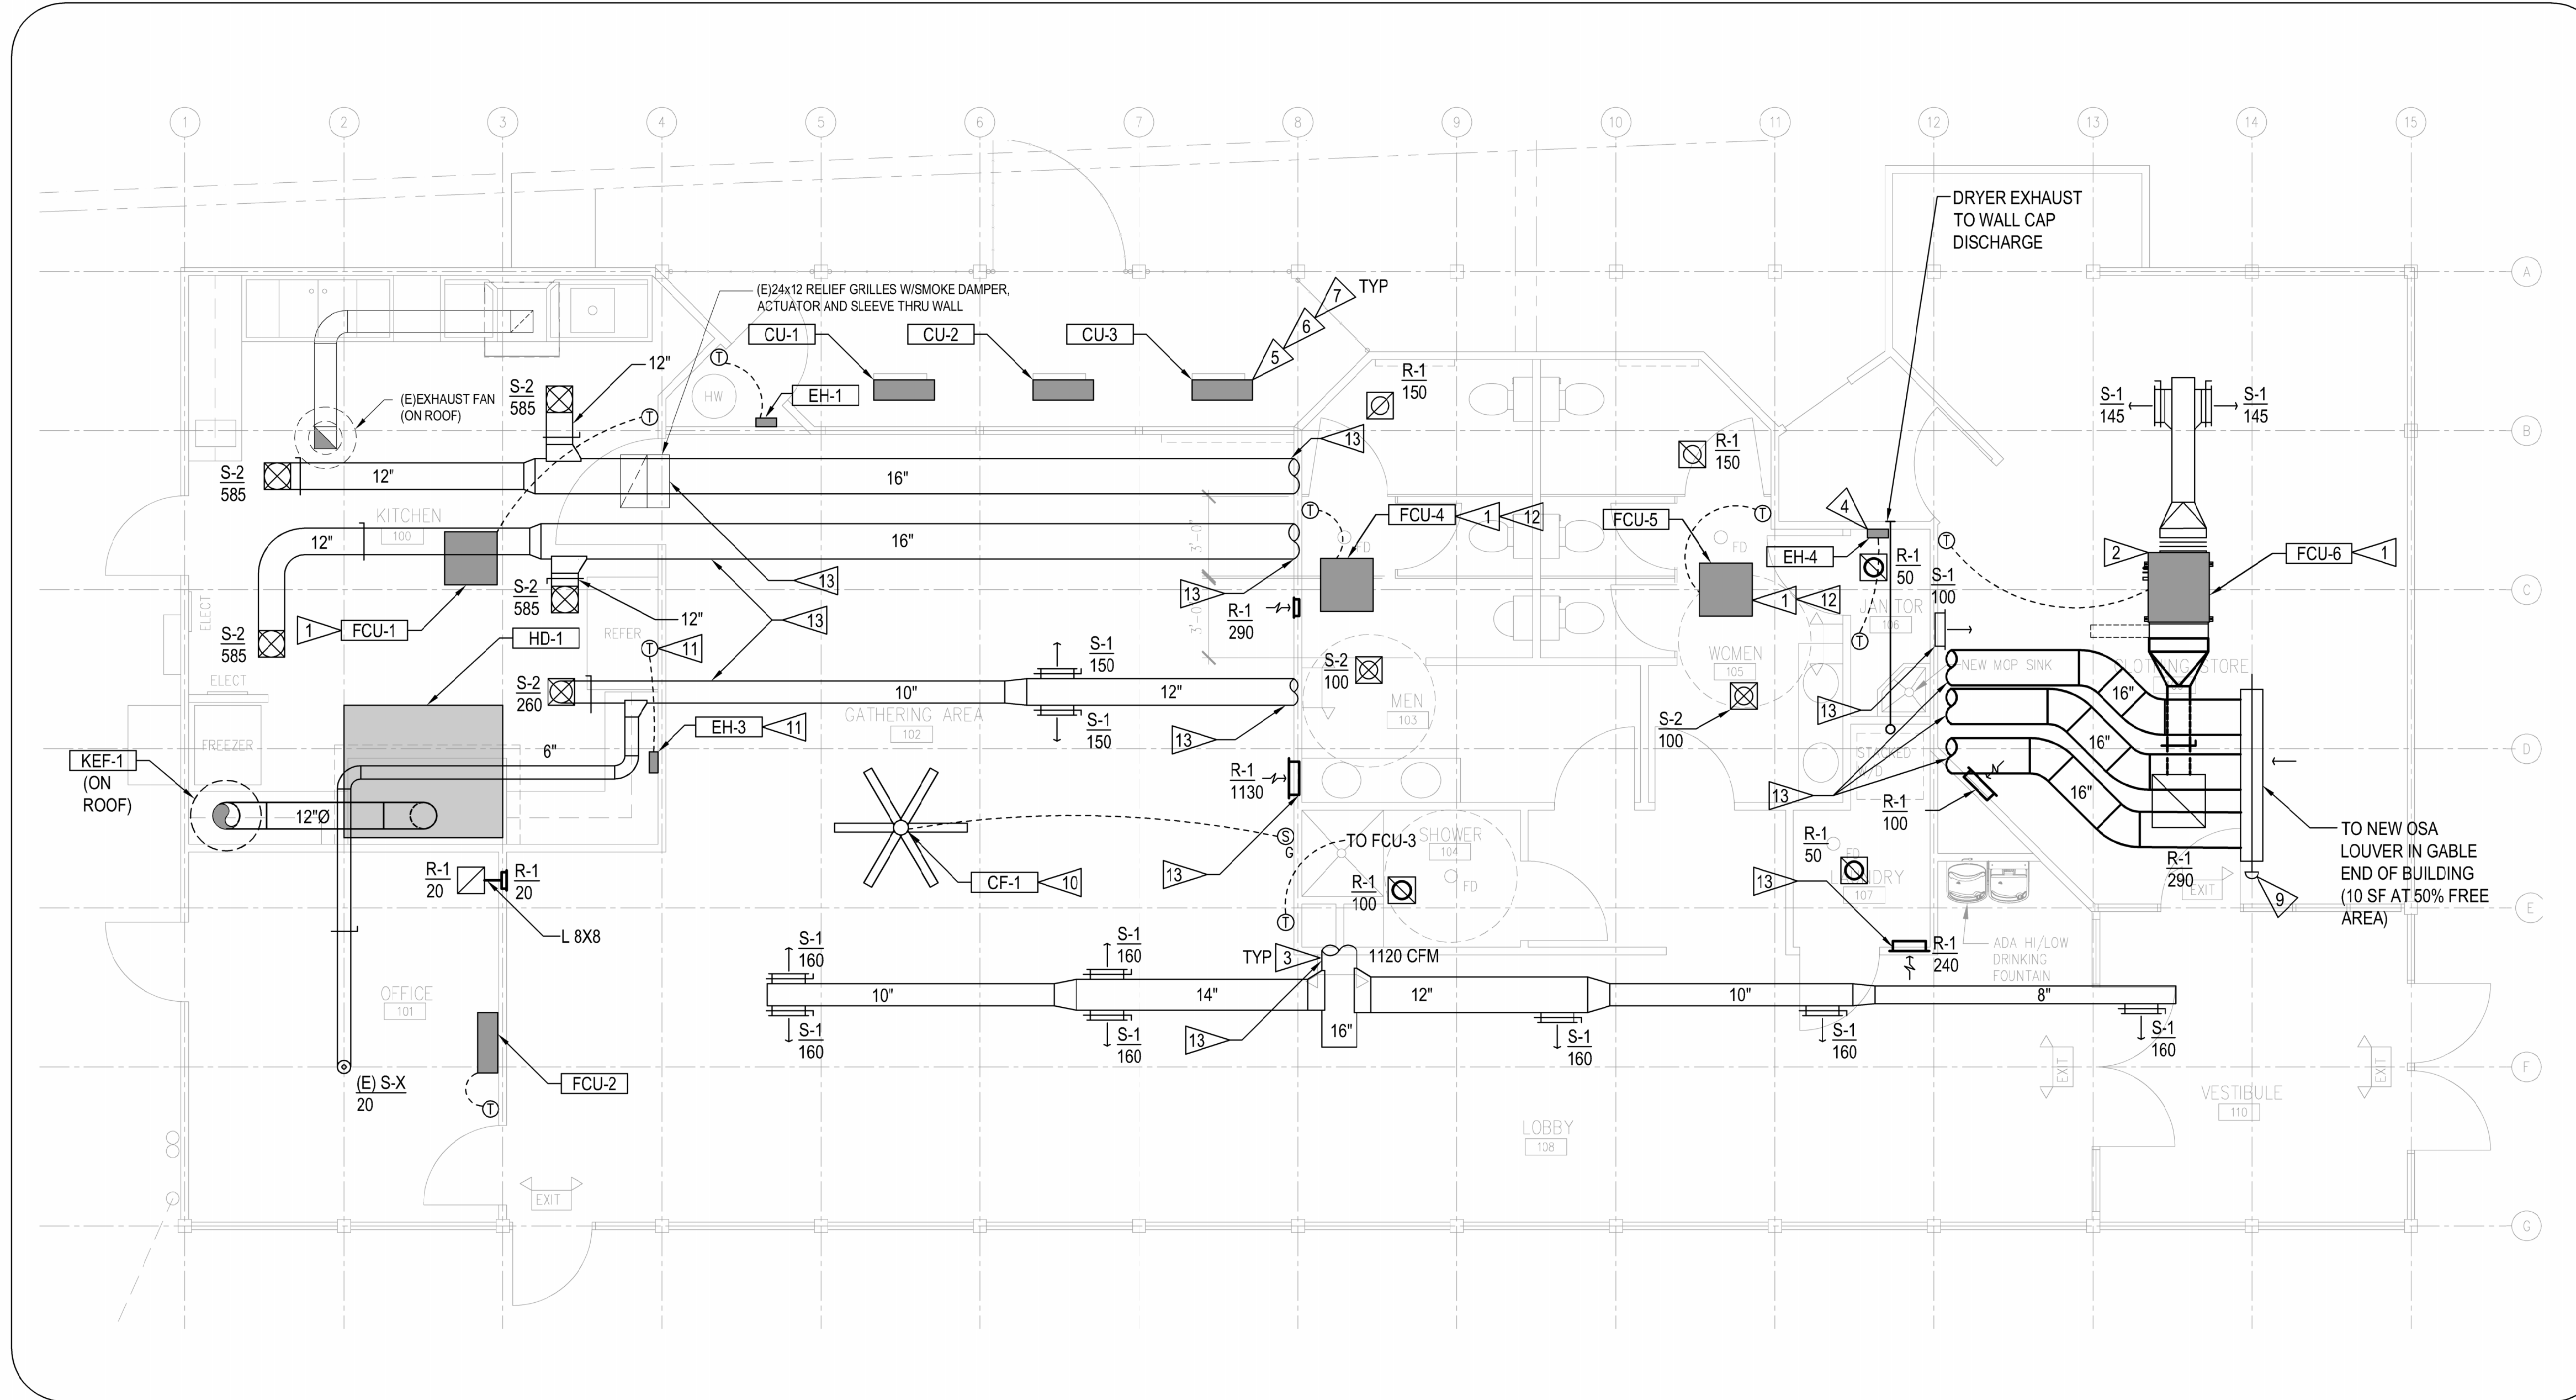

1 MECHANICAL PLAN
M1.1 SCALE: 1/4" = 1'-0"

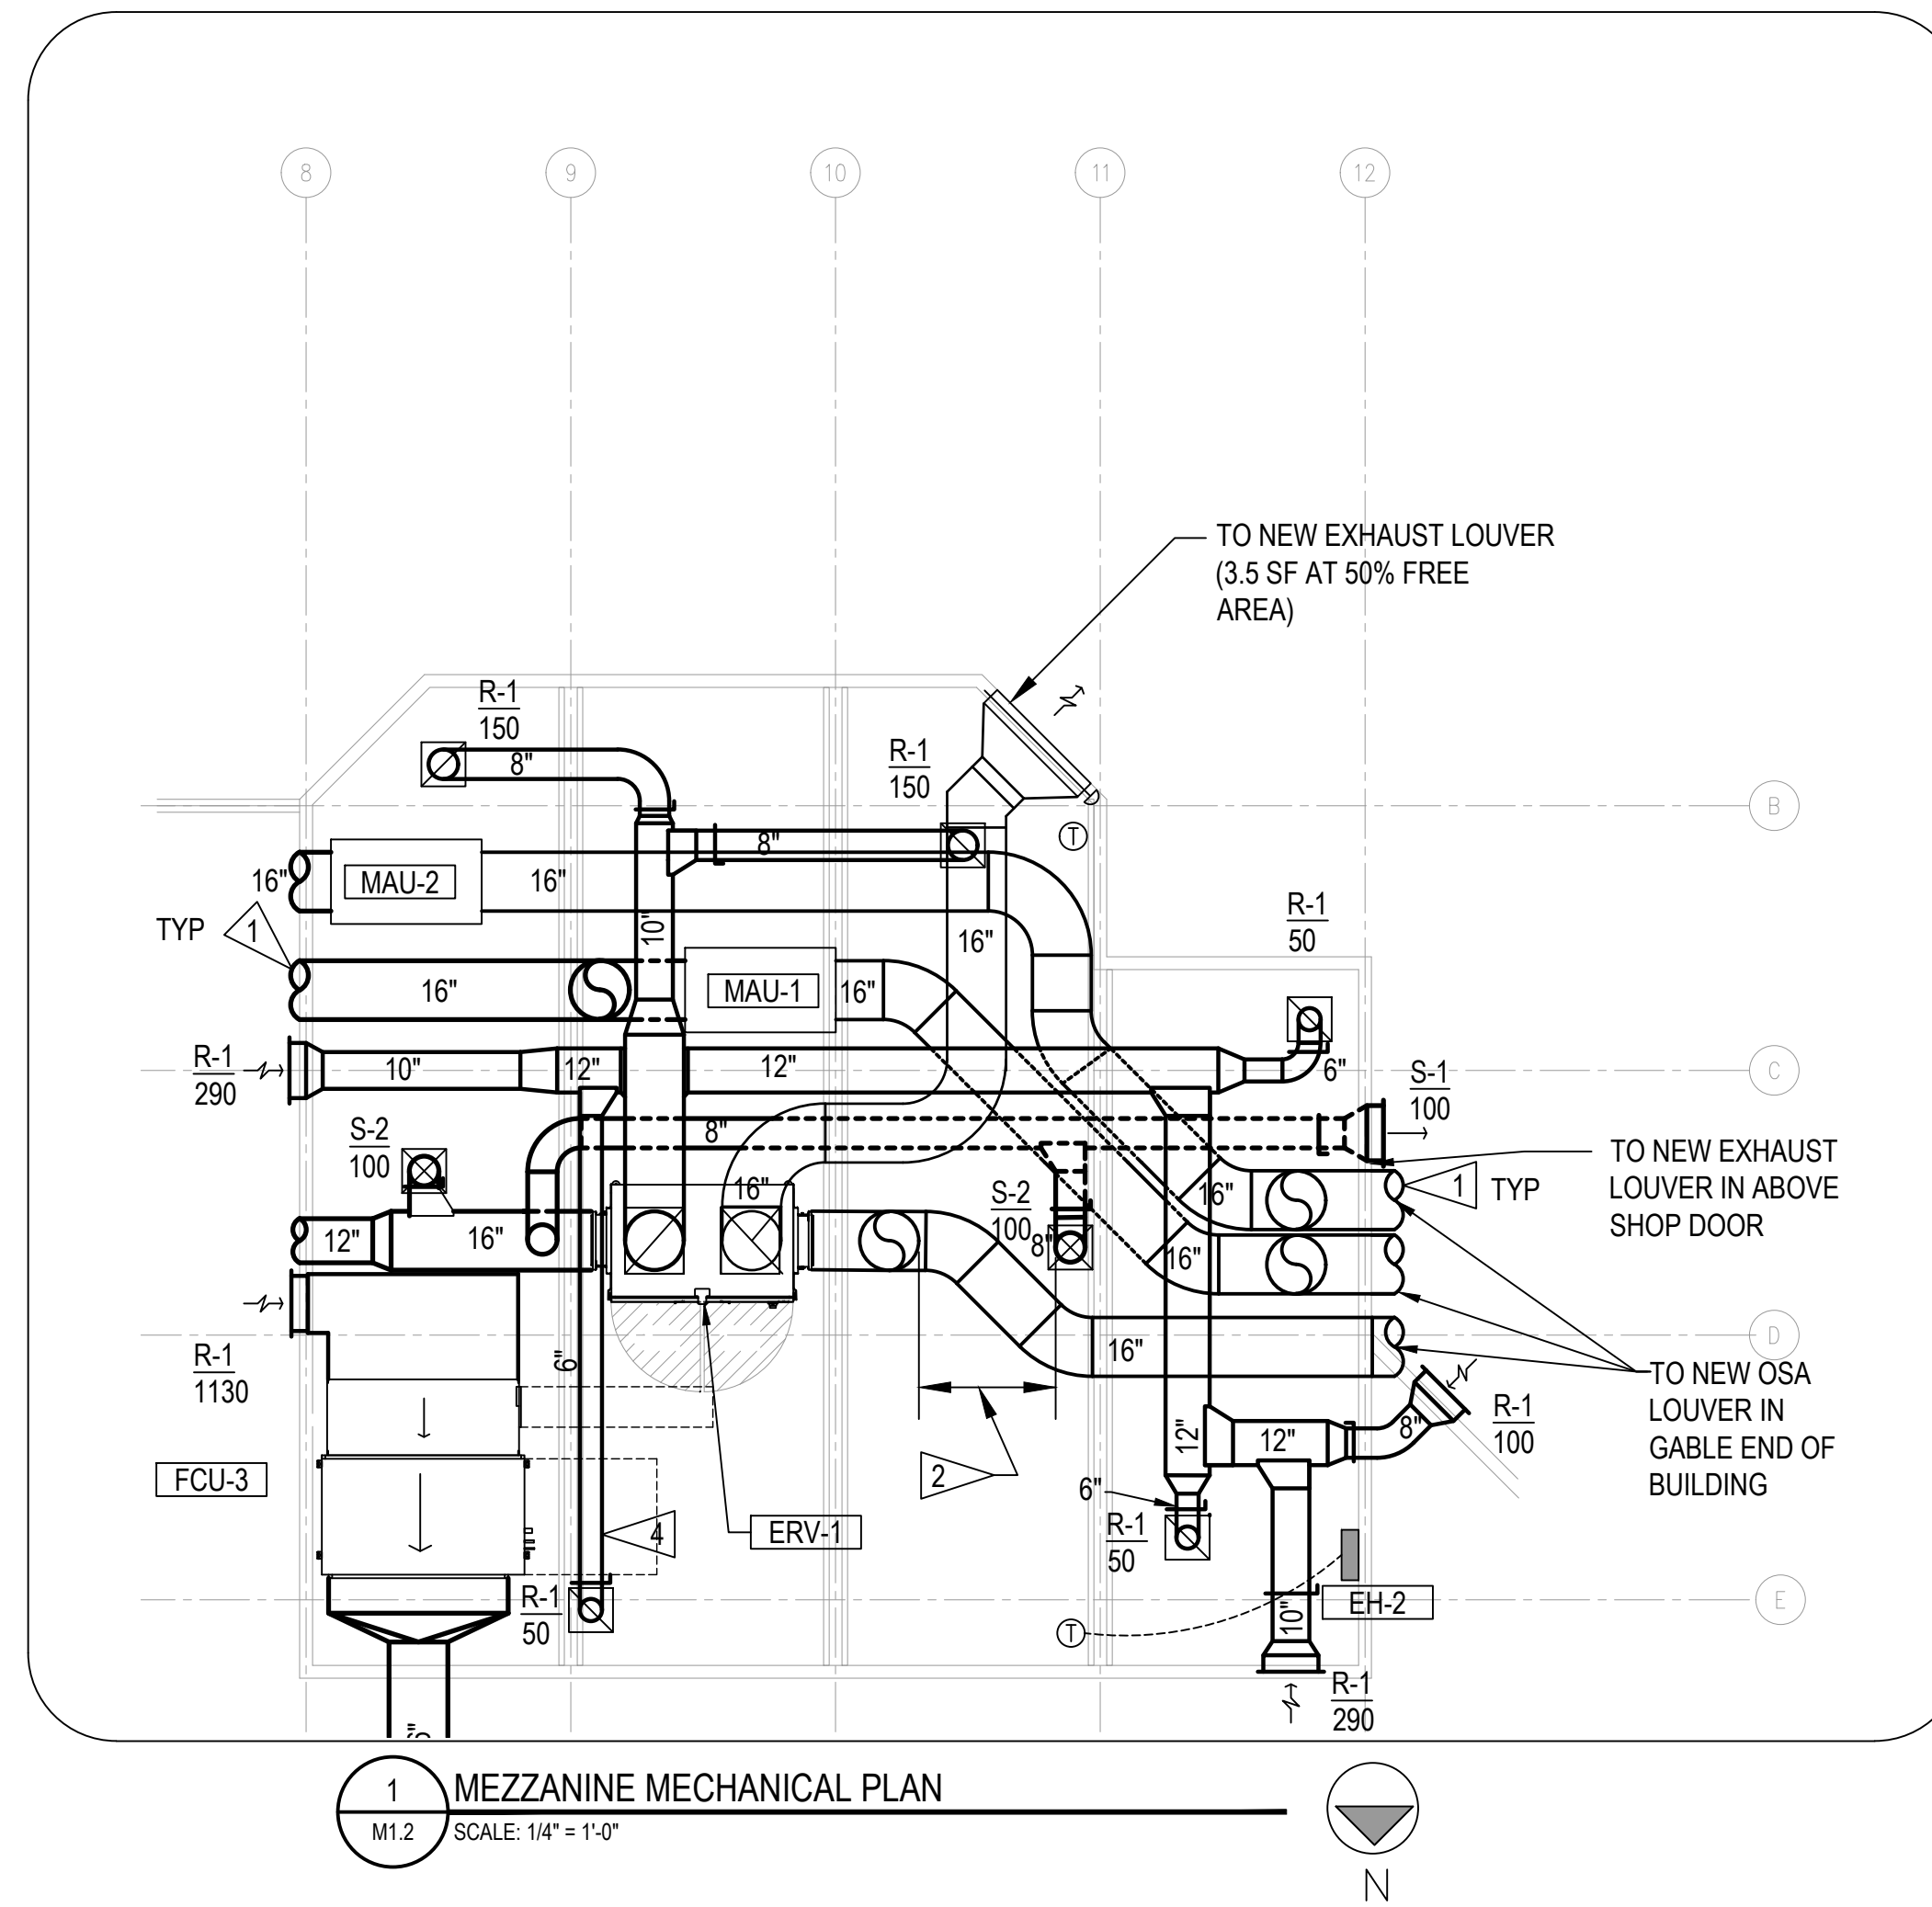


1 MEZZANINE MECHANICAL PLAN
M1.2 SCALE: 1/4" = 1'-0"

GENERAL NOTES:


1. MAINTAIN MINIMUM 10 FT SEPARATION OF OUTSIDE AIR INTAKES FROM EXHAUST AIR OUTLETS:
 - LOT LINES (ON STREET OR PUBLIC WAY, DISTANCE SHALL BE MEASURED FROM OPPOSITE SIDE OF STREET OR PUBLIC WAY)
 - VENTS
 - STREETS
 - ALLEYS
 - PARKING LOTS
 - LOADING DOCKS
2. EXHAUST AIR OUTLETS, VENTS, FLUES SHALL MAINTAIN A MINIMUM OF:
 - 3 FT FROM OPERABLE OPENINGS (INCLUDES DOORS AND WINDOWS)
 - 3 FT FROM PROPERTY LINES
 - 10 FT FROM OUTSIDE AIR INTAKES
3. CONTRACTOR SHALL COORDINATE LOCATION OF ALL ACCESS DOORS AND PANELS FOR EQUIPMENT AND ACCESSORIES.
4. FIELD COORDINATE CONDENSATE DRAIN PIPING ROUTING TO APPROVED DISCHARGE LOCATION
5. PROVIDE VOLUME DAMPER FOR EACH GRILLE REGISTER AND DIFFUSER DUCT BRANCH

KEYED NOTES:

- 1 SEE M1.1 FOR CONTINUATION.
- 2 MAINTAIN 36" ACCESS PATH.
- 3 MAXIMIZED DUCT MOUNT HEIGHT IN ATTIC FROM MAINTAINANCE ACCESS.
- 4 KEEP DUCTS CLEAR OF MAINTAINANCE/ELECTRICAL CLEARANCES
- 4 PROVIDE MOTORIZED DAMPER AT BUILDING ENVELOPE.

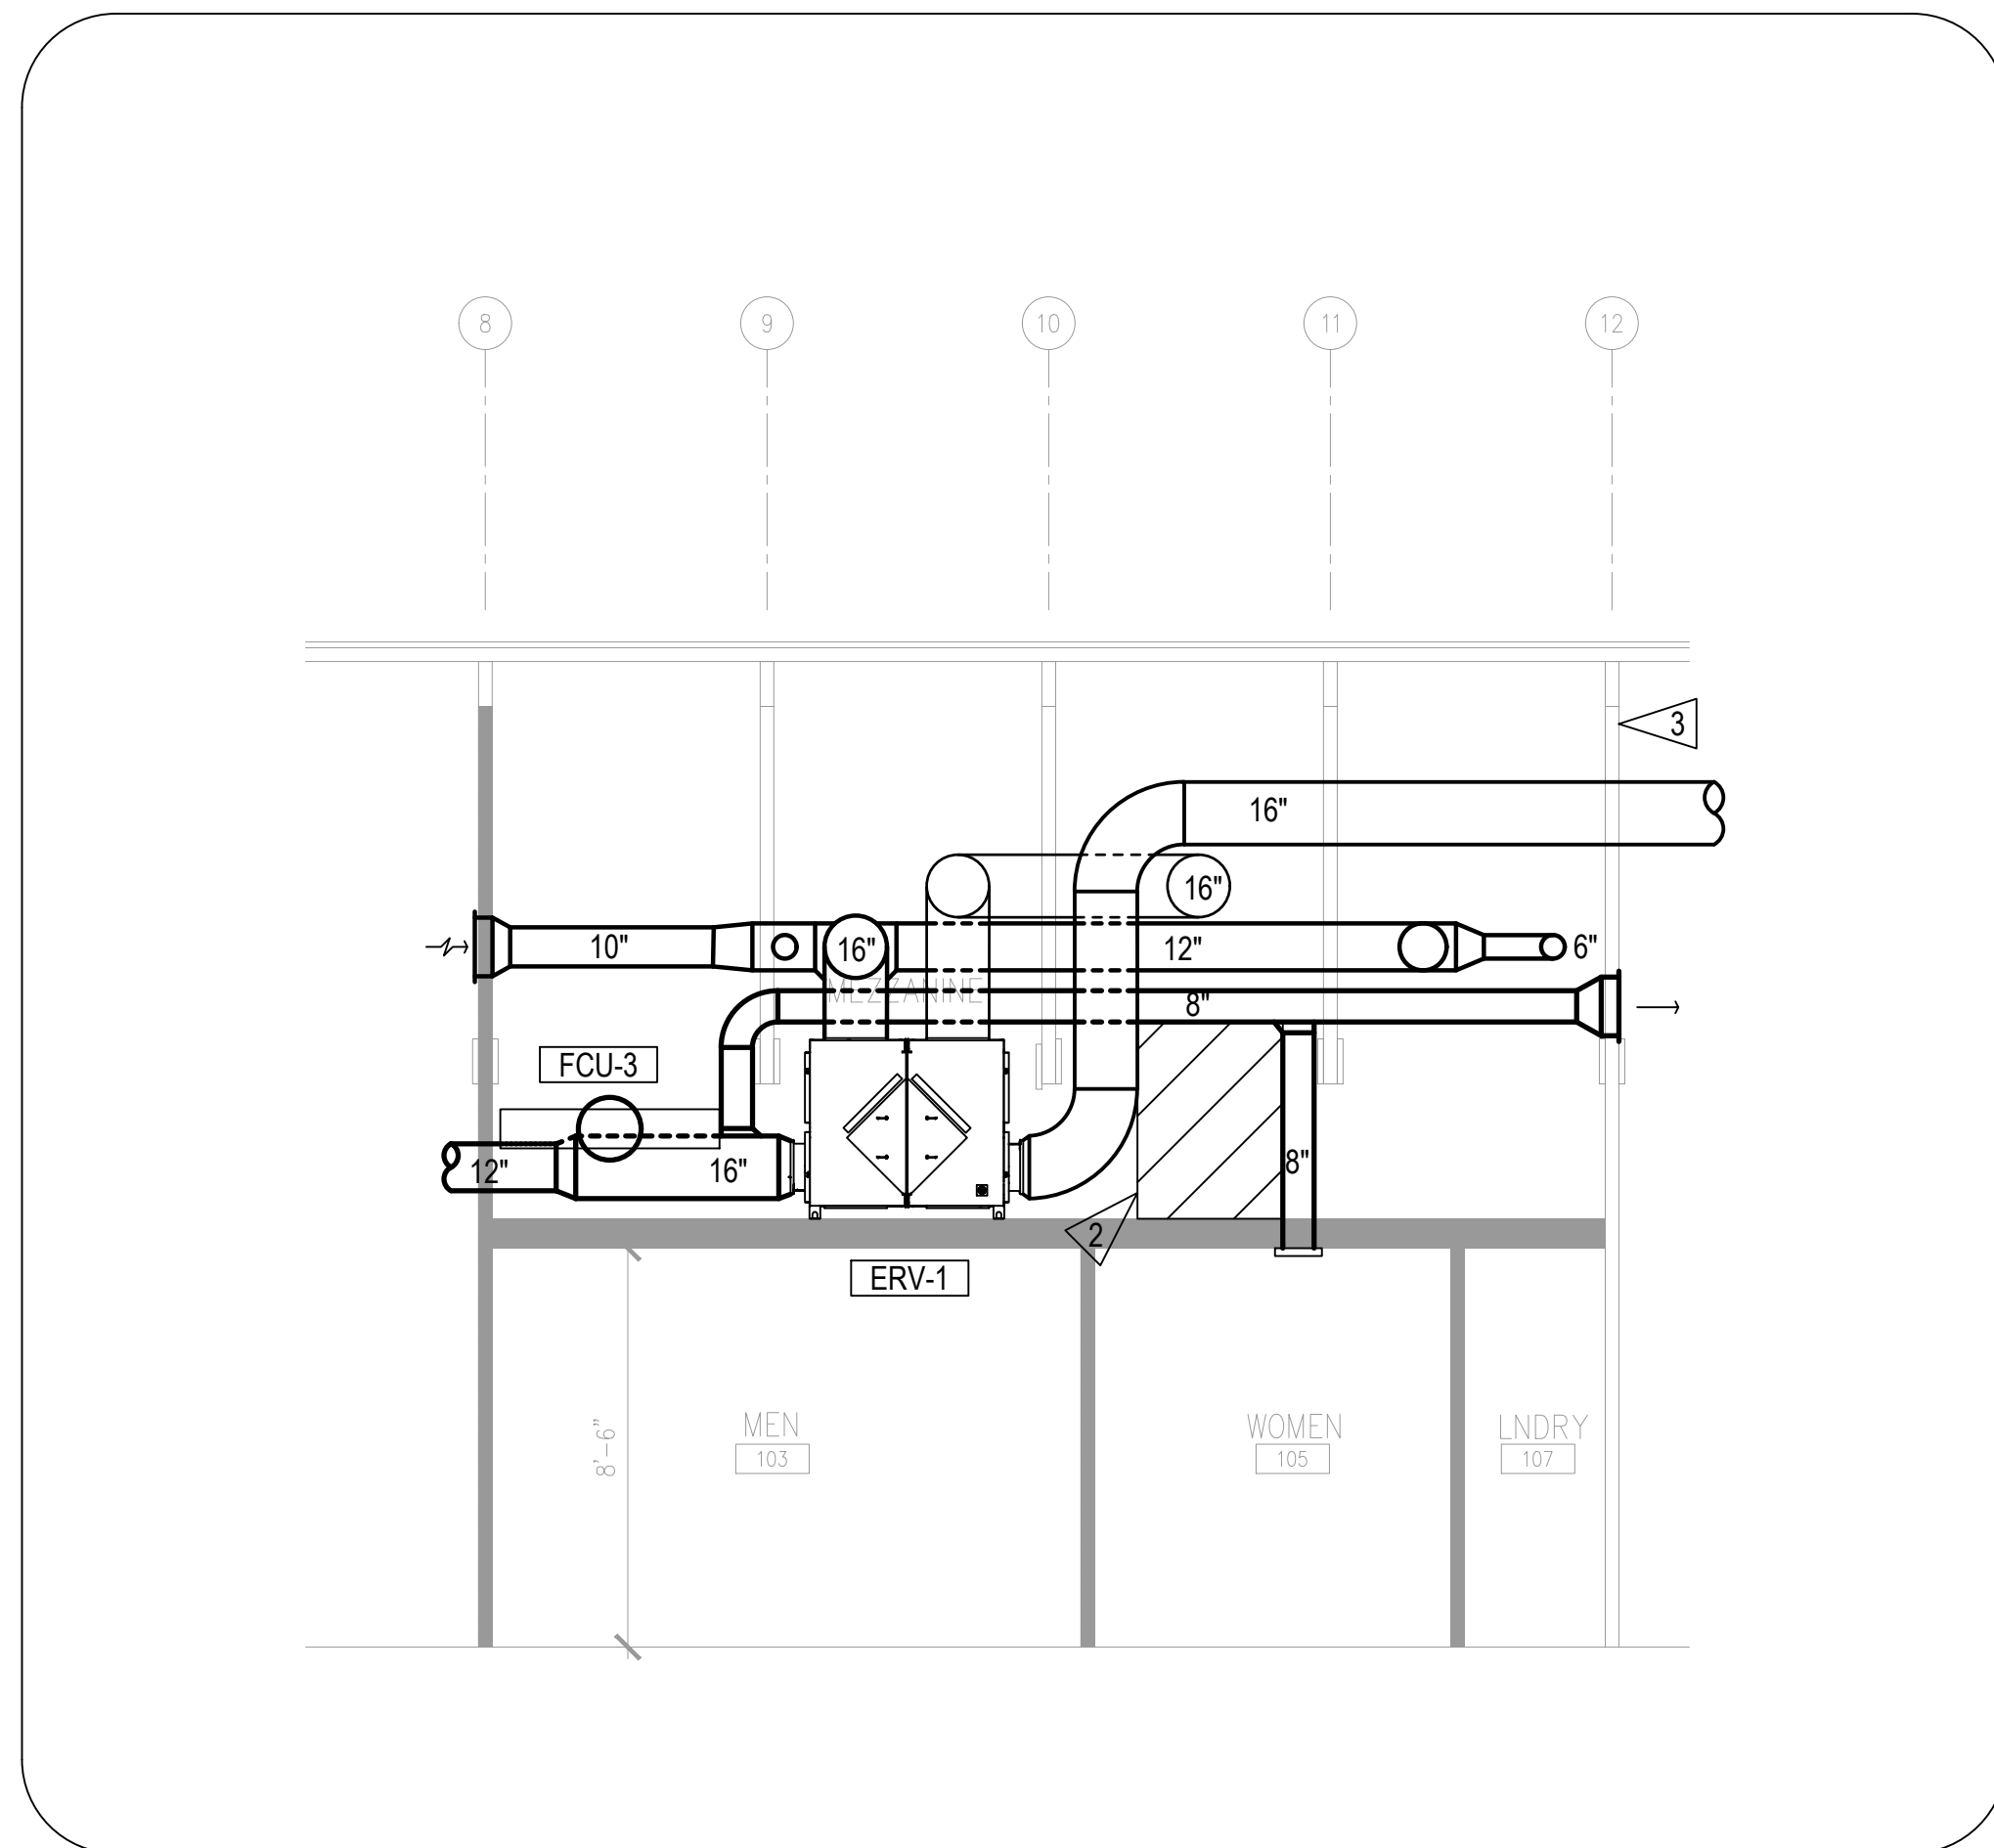


2 SECTIONS
M1.2 SCALE: 1/4" = 1'-0"

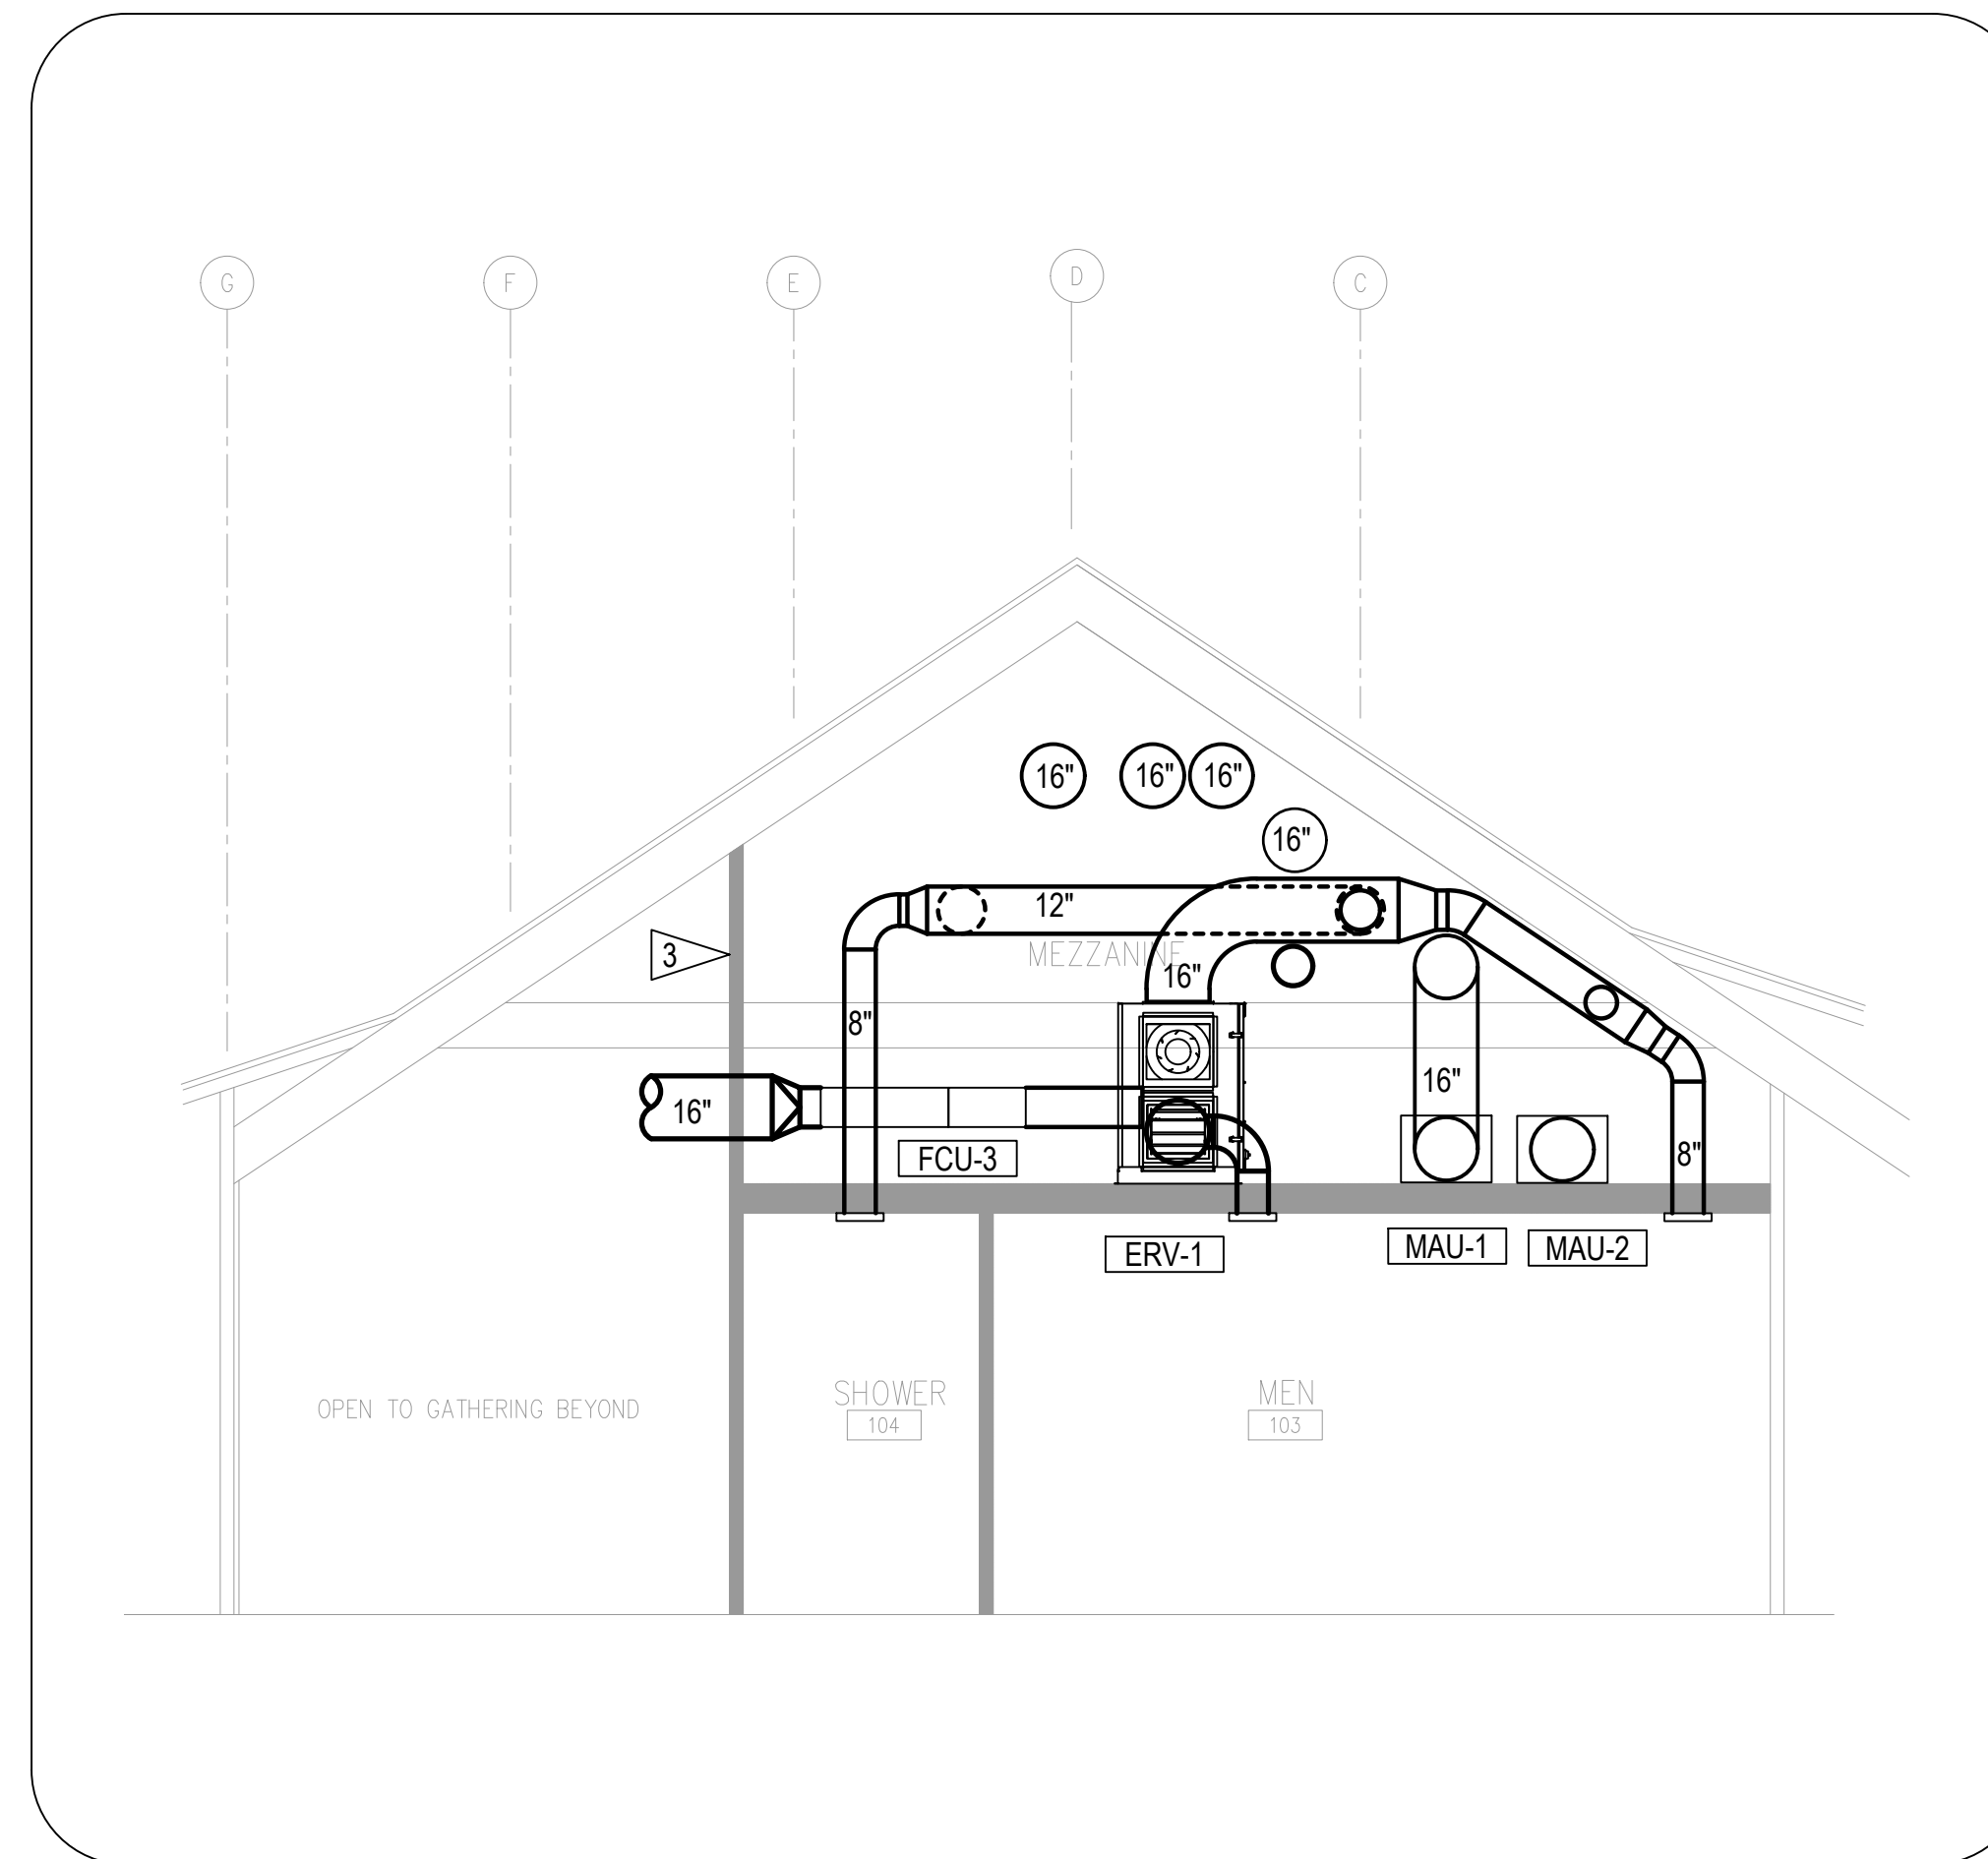

2 SECTIONS
M1.2 SCALE: 1/4" = 1'-0"



JTK ENGINEERING
HVAC | PLUMBING | ENERGY
WWW.JTKENG.COM

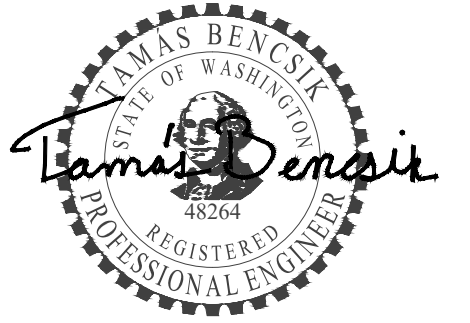

February 15, 2025



CARLETTI ARCHITECTS P.S.
ARCHITECTS, DESIGN, INTERIOR DESIGN
116 EAST FIR STREET
SUITE A
MOUNT VERNON, WA 98273
Phone: (360) 434-6384
Fax: (360) 424-3726



**SKAGIT COUNTY
CONCRETE COMMUNITY
CENTER**

REVISIONS

NO.	DATE	DESCRIPTION

stage: **BID SET**

client: **CARLETTI ARCHITECTS**

project: **CONCRETE COMMUNITY CENTER
45821 RAILROAD AVE
CONCRETE,
WASHINGTON**

drawn by: **NH**

original sheet size: **24x36**

revision: **None**

date: **2025.02.18**

scale:


**MEZZANINE
MECHANICAL
PLAN**

sheet:

M1.2



JTK ENGINEERING
HVAC | PLUMBING | ENERGY
WWW.JTKENG.COM

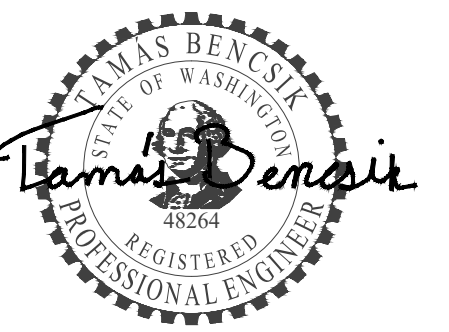

February 15, 2025



CARLETTI ARCHITECTS P.S.
ARCHITECTS, PLANNING, INTERIOR DESIGN
116 EAST FIR STREET
SUITE A
MOUNT VERNON, WA 98273
Phone: (360) 434-6384
Fax: (360) 424-3726



**SKAGIT COUNTY
CONCRETE COMMUNITY
CENTER**

REVISIONS

NO.	DATE	DESCRIPTION

stage: **BID SET**

client: **CARLETTI ARCHITECTS**

project: **CONCRETE COMMUNITY CENTER
45821 RAILROAD AVE
CONCRETE,
WASHINGTON**

drawn by: **NH**

original sheet size: **24x36**

revision: **None**

date: **2025.02.18**

scale:

**STORAGE
MECHANICAL
PLAN**

sheet.


M1.3

GENERAL NOTES:

1. MAINTAIN MINIMUM 10 FT SEPARATION OF OUTSIDE AIR INTAKES FROM EXHAUST AIR OUTLETS:
 - LOT LINES (ON STREET OR PUBLIC WAY, DISTANCE SHALL BE MEASURED FROM OPPOSITE SIDE OF STREET OR PUBLIC WAY)
 - VENTS
 - STREETS
 - ALLEYS
 - PARKING LOTS
 - LOADING DOCKS
2. EXHAUST AIR OUTLETS, VENTS, FLUES SHALL MAINTAIN A MINIMUM OF:
 - 3 FT FROM OPERABLE OPENINGS (INCLUDES DOORS AND WINDOWS)
 - 3 FT FROM PROPERTY LINES
 - 10 FT FROM OUTSIDE AIR INTAKES
3. CONTRACTOR SHALL COORDINATE LOCATION OF ALL ACCESS DOORS AND PANELS FOR EQUIPMENT AND ACCESSORIES.
4. FIELD COORDINATE CONDENSATE DRAIN PIPING ROUTING TO APPROVED DISCHARGE LOCATION
5. PROVIDE VOLUME DAMPER FOR EACH GRILLE REGISTER AND DIFFUSER DUCT BRANCH


KEYED NOTES:

- 1 PROVIDE NEW REFRIGERATION EQUIPMENT.
- 2 FIELD COORDINATE CONDENSATE DRAIN ROUTING.
- 3 MAINTAIN DISTANCES FROM WALLS PER MANUFACTURERS INSTRUCTIONS.
- 4 PROVIDE PIPING VIA WEATHER TIGHT WALL PENETRATION FROM GROUND MOUNTED EQUIPMENT.
- 5 PROVIDE 4" HOUSEKEEPING PAD.

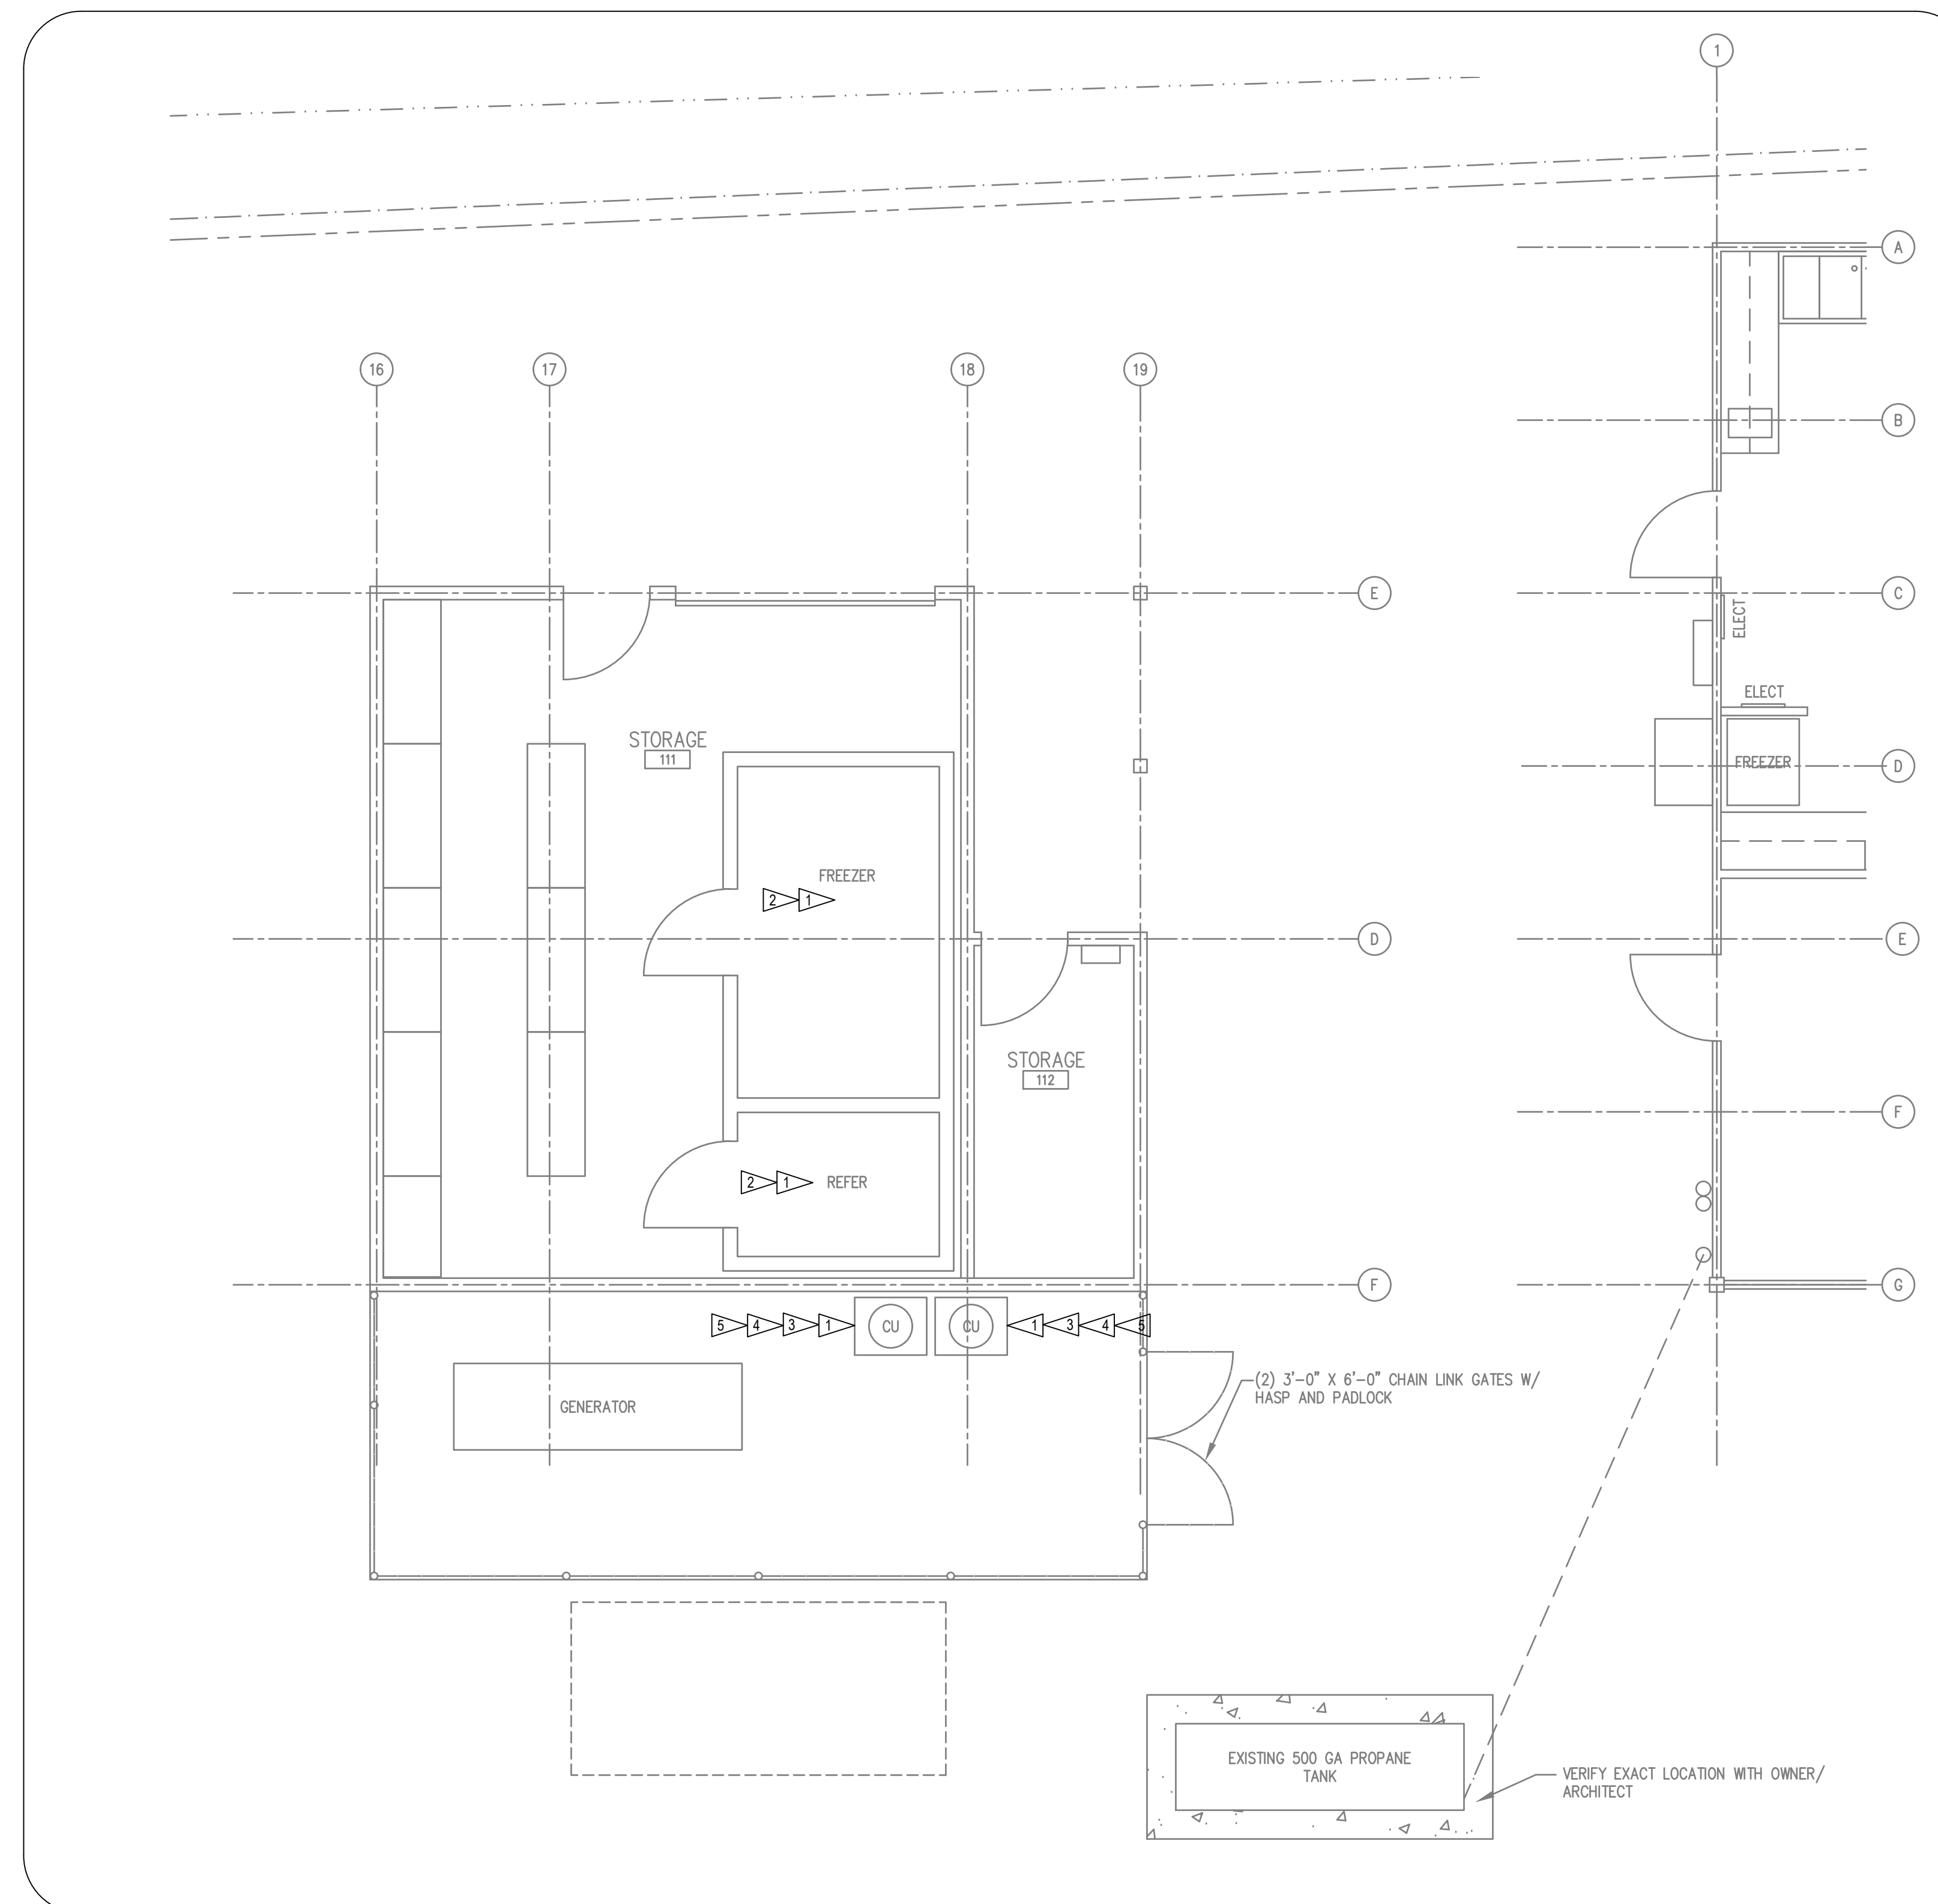


1 STORAGE MECHANICAL PLAN
M1.3 SCALE: 1/4" = 1'-0"




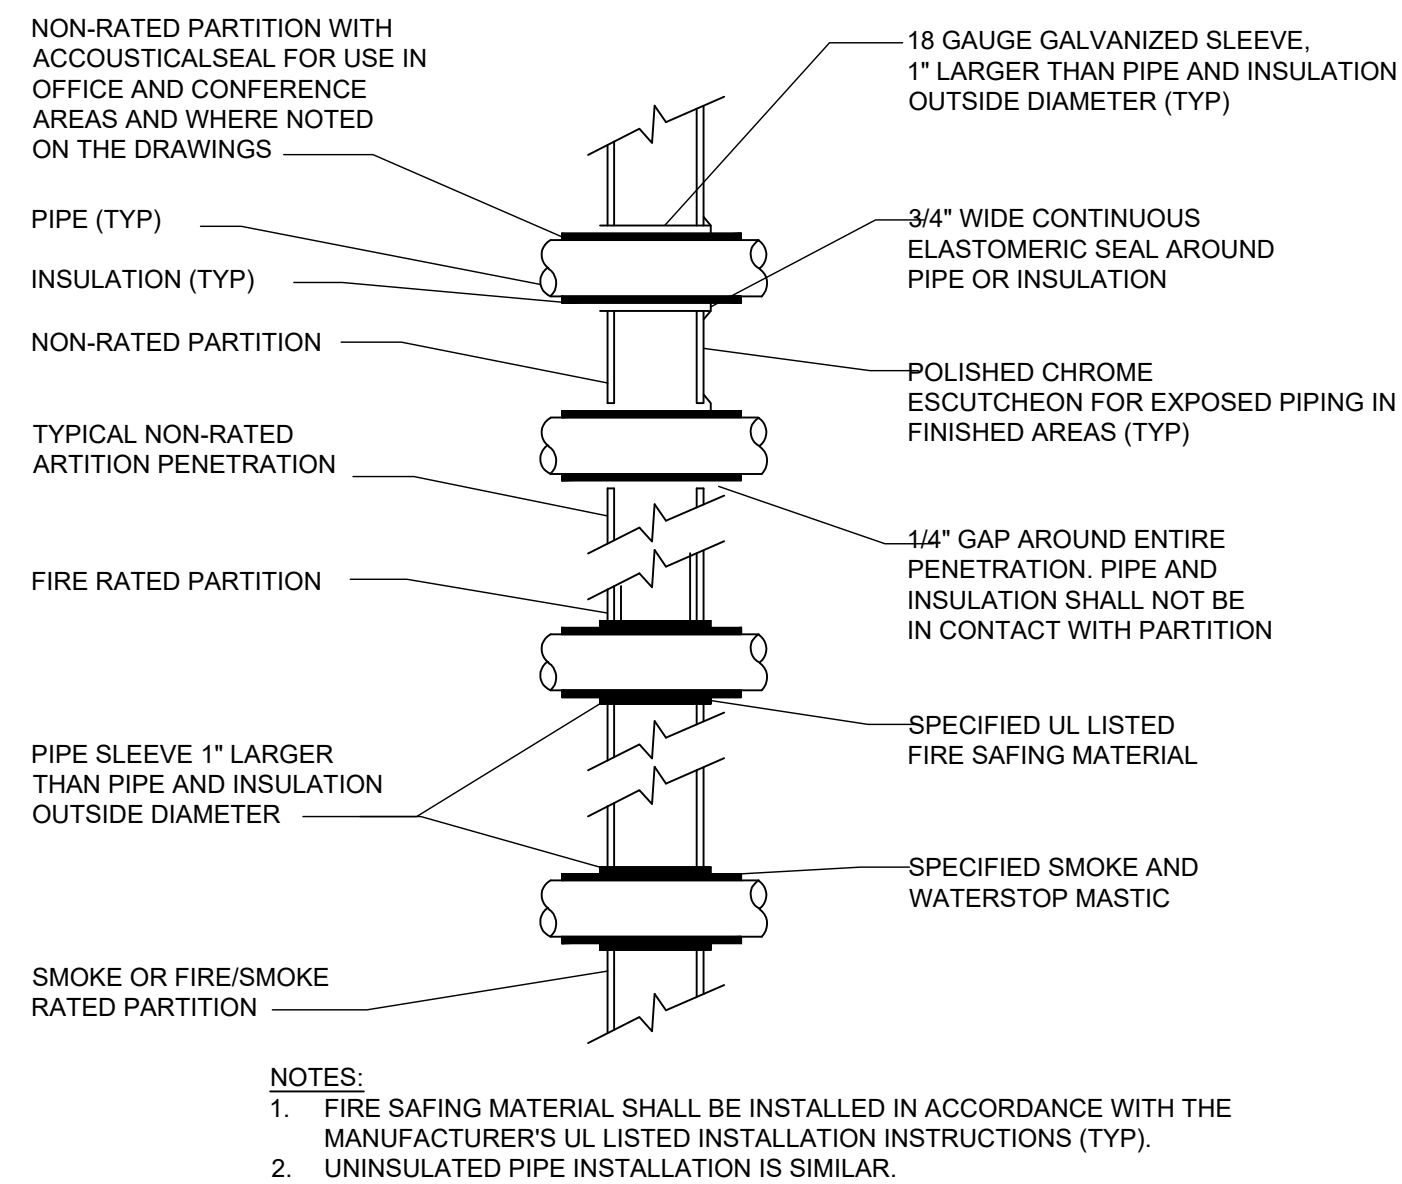


1 TYPICAL PIPE WALL SLEEVES DETAIL
N.T.S.

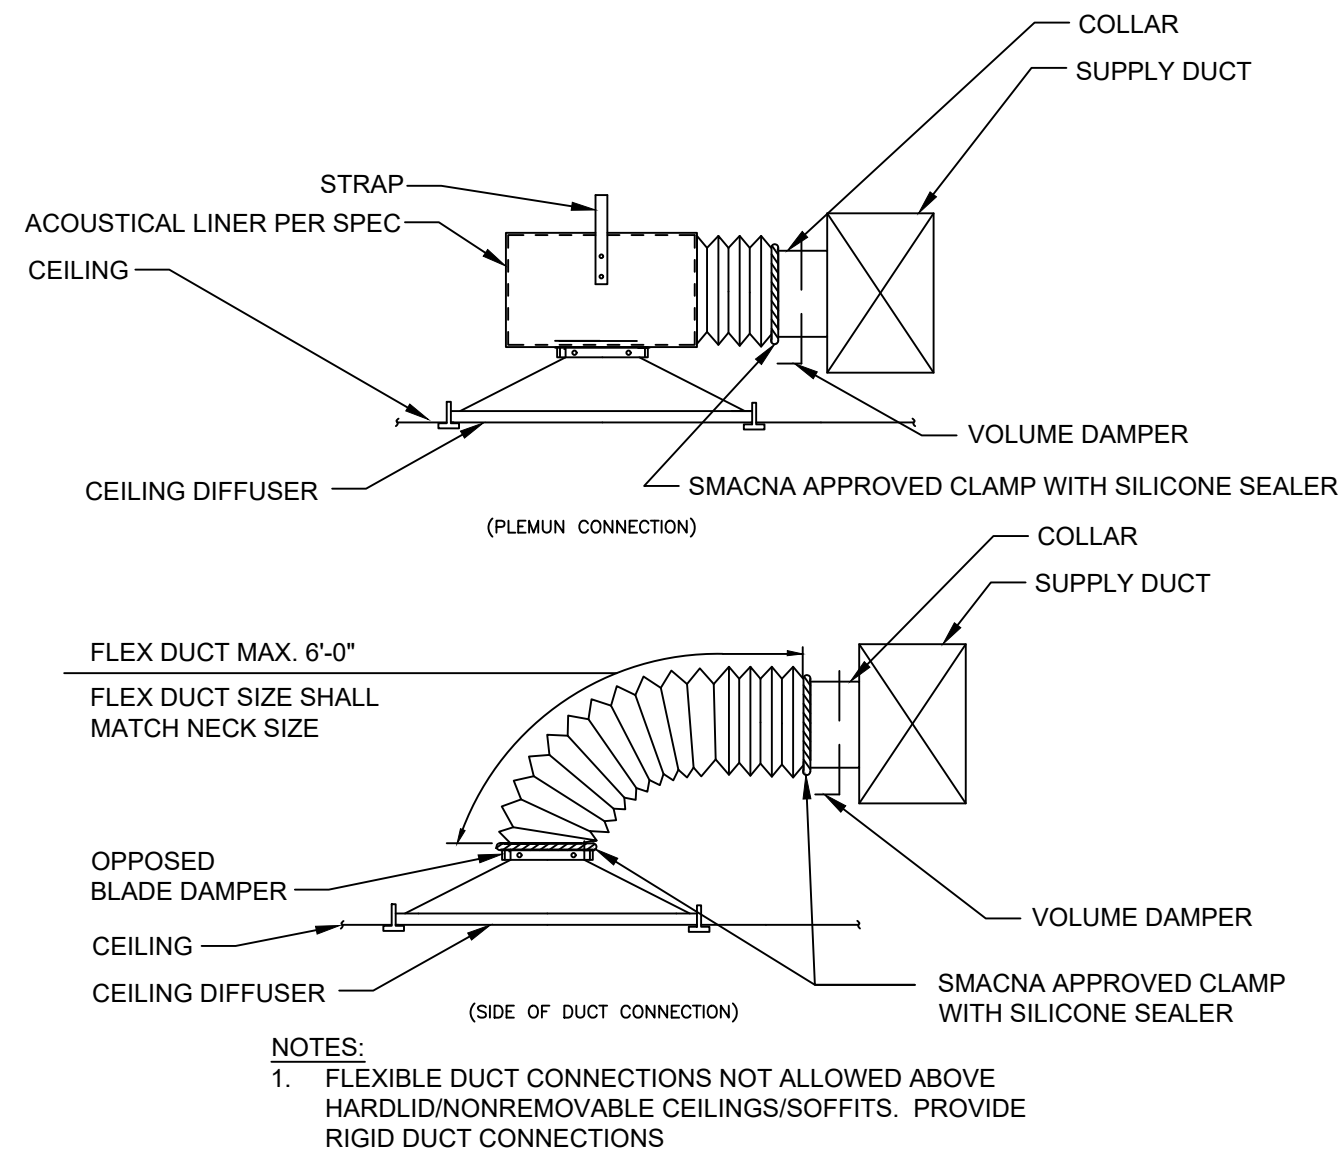


2 DIFFUSER CONNECTION DETAIL
N.T.S. (SIDE OF DUCT CONNECTION)

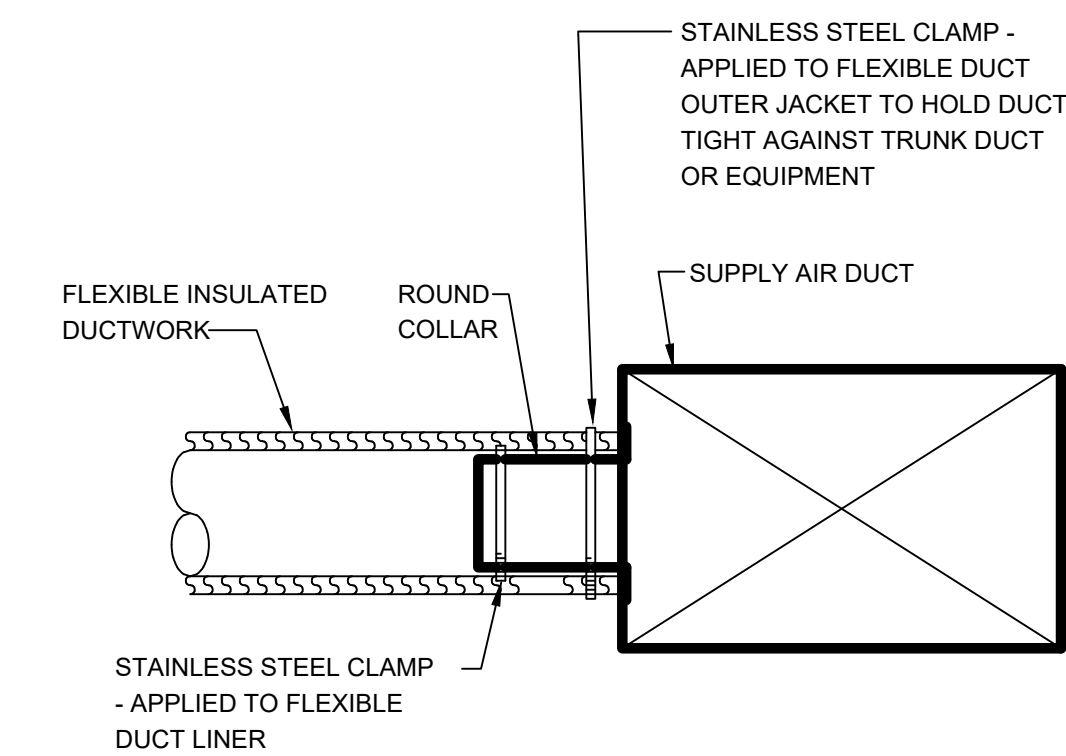

3 TYPICAL FLEXIBLE DUCT CONNECTION DETAIL
N.T.S.

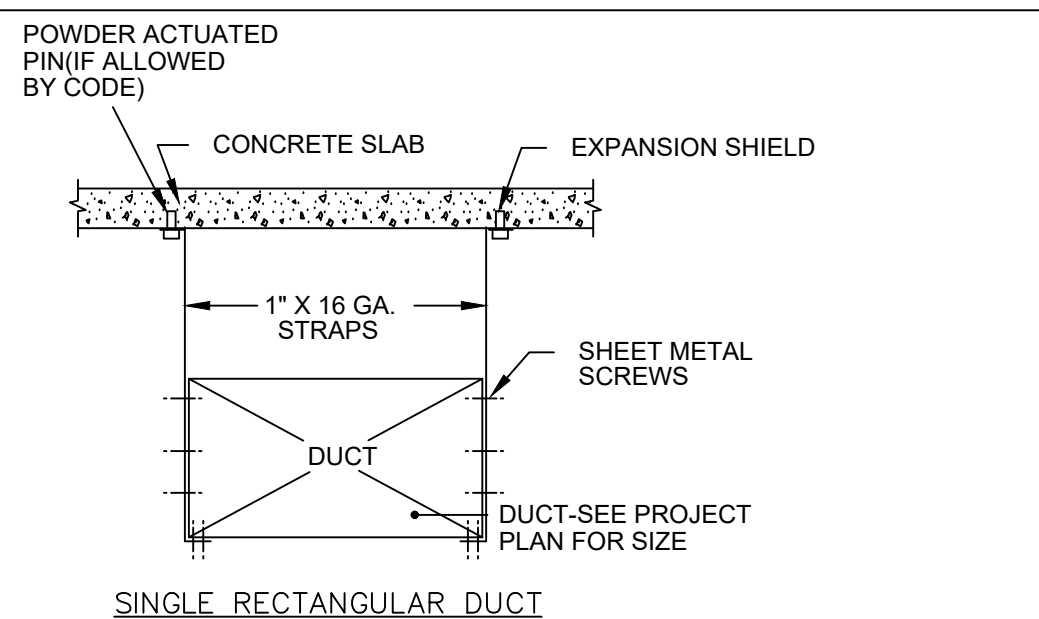


SINGLE RECTANGULAR DUCT

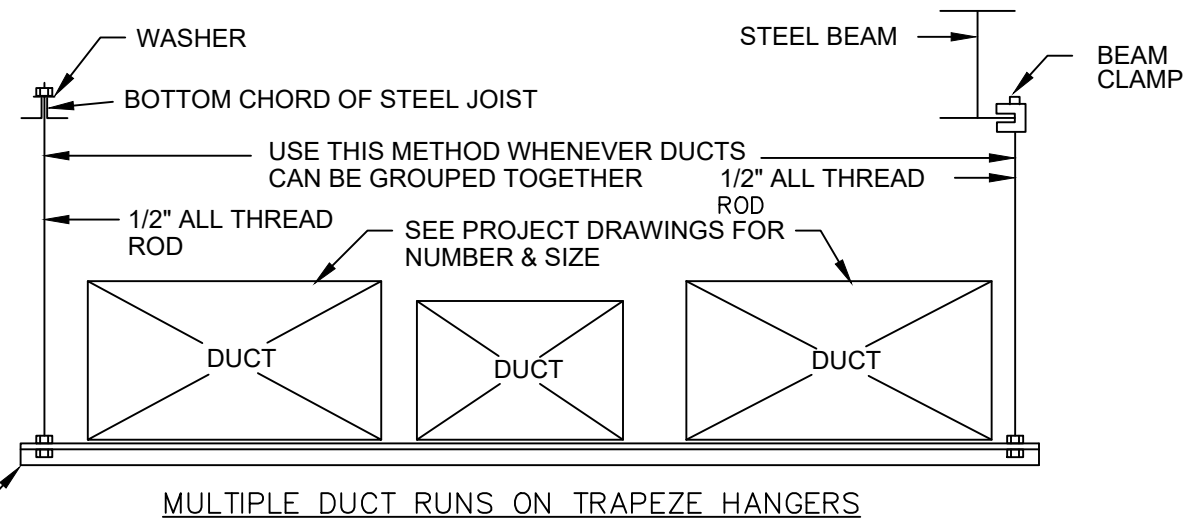


MULTIPLE DUCT RUNS ON TRAPEZE HANGERS

4 LOW PRESSURE DUCTWORK HANGARS AND SUPPORTS
N.T.S. LOW PRESSURE DUCTWORK (UP THRU 2\"/>

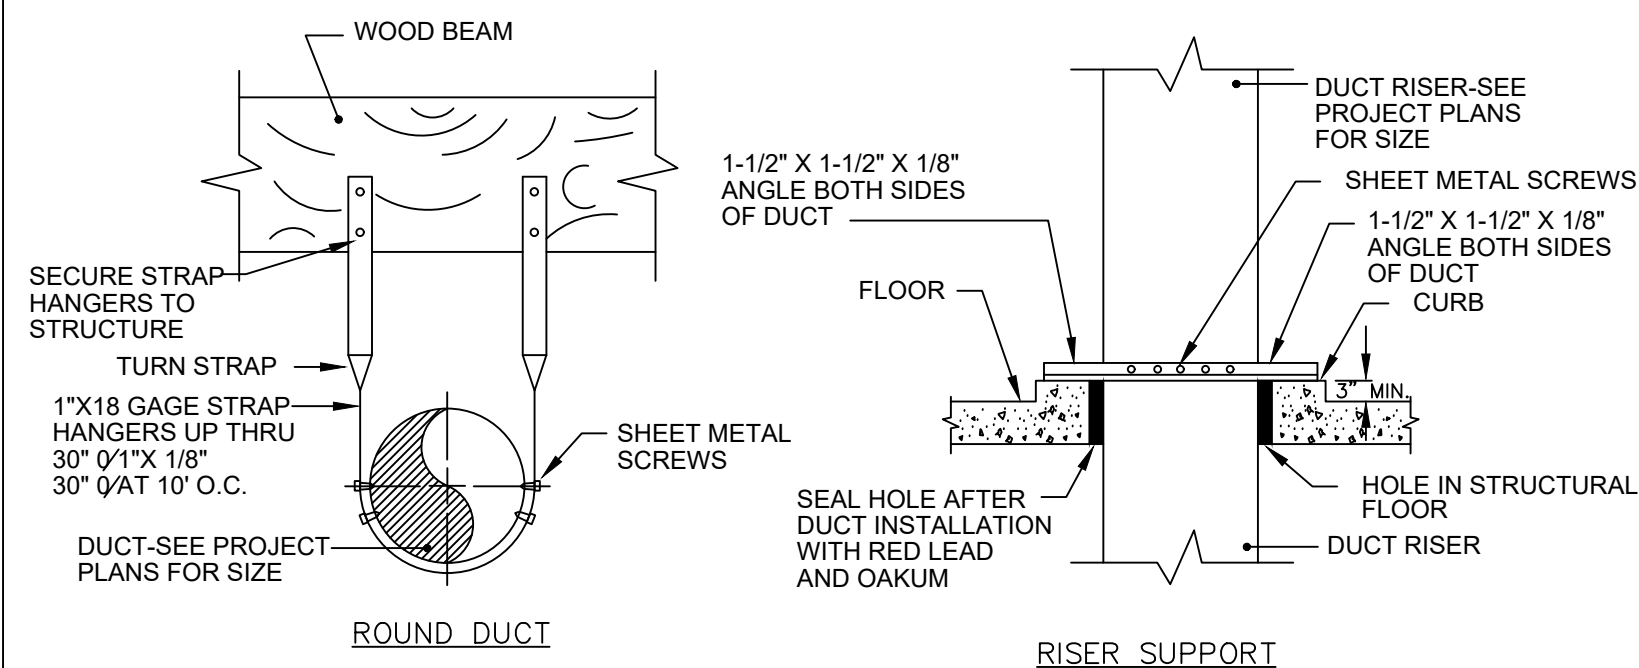


ROUND DUCT

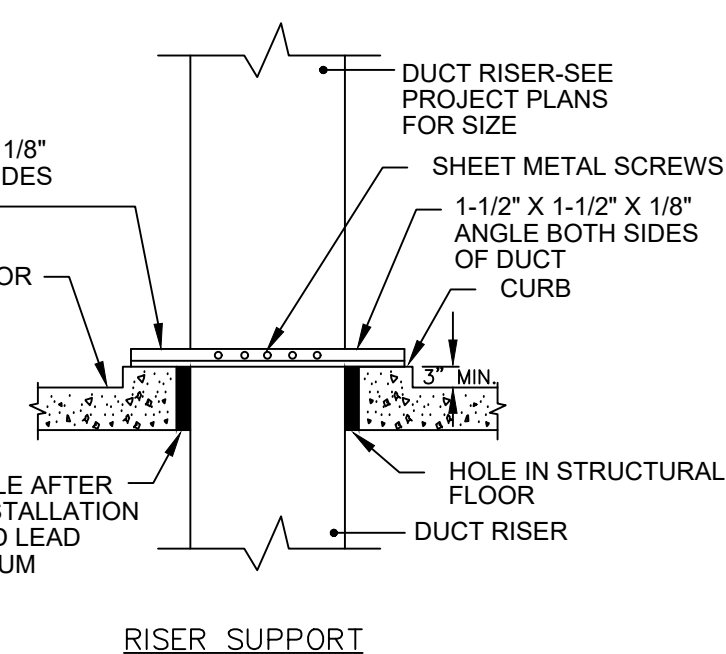

RISER SUPPORT


5 LOW PRESSURE DUCTWORK HANGARS AND SUPPORTS
N.T.S. LOW PRESSURE DUCTWORK (UP THRU 2\"/>

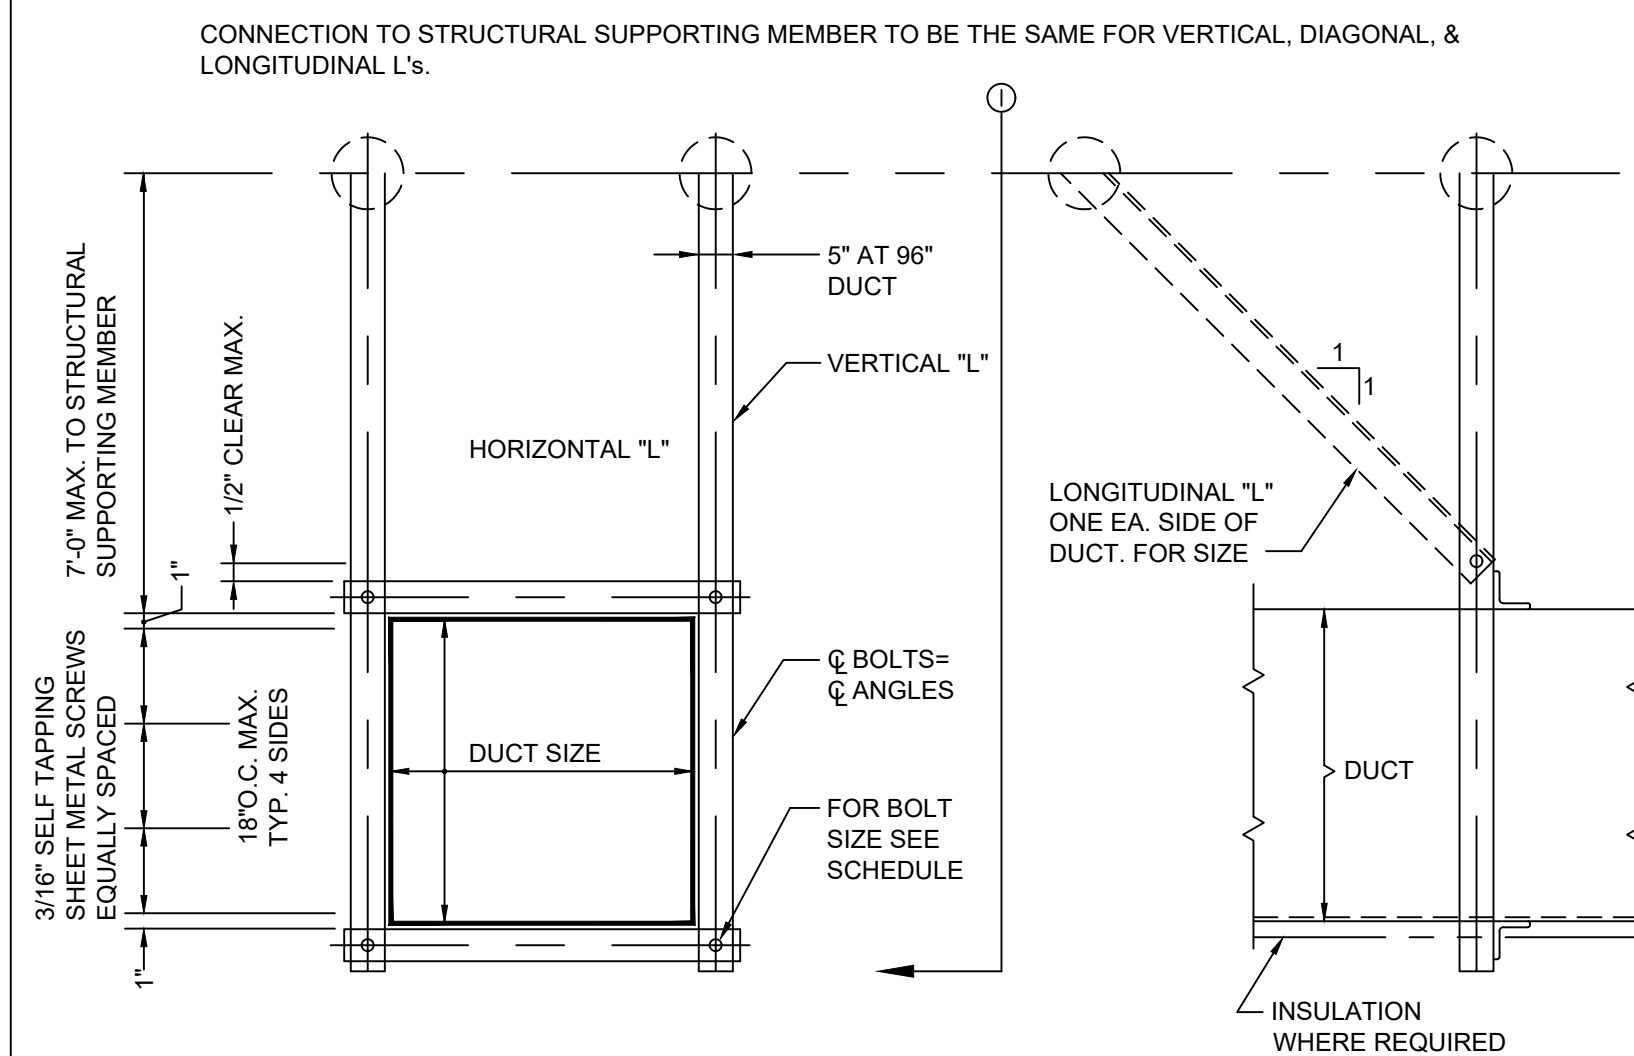

6 RECTANGULAR DUCT BRACING DETAIL
N.T.S.



JTK ENGINEERING
HVAC | PLUMBING | ENERGY
WWW.JTKENG.COM

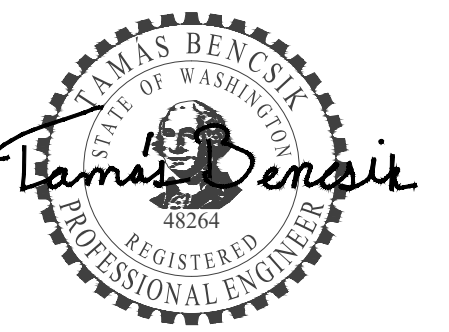

February 15, 2025



CARLETTI ARCHITECTS P.S.
116 EAST FR STREET
SUITE A
MOUNT VERNON, WA 98273
Phone: (360) 434-6384
Fax: (360) 424-3726



**SKAGIT COUNTY
CONCRETE COMMUNITY
CENTER**

REVISIONS

stage: **BID SET**

client: **CARLETTI ARCHITECTS**

project: **CONCRETE COMMUNITY CENTER
45821 RAILROAD AVE
CONCRETE,
WASHINGTON**

drawn by: **NH**

original sheet size: **24x36**

revision: **None**


date: **2025.02.18**

scale:


DETAILS

sheet:


M3.0

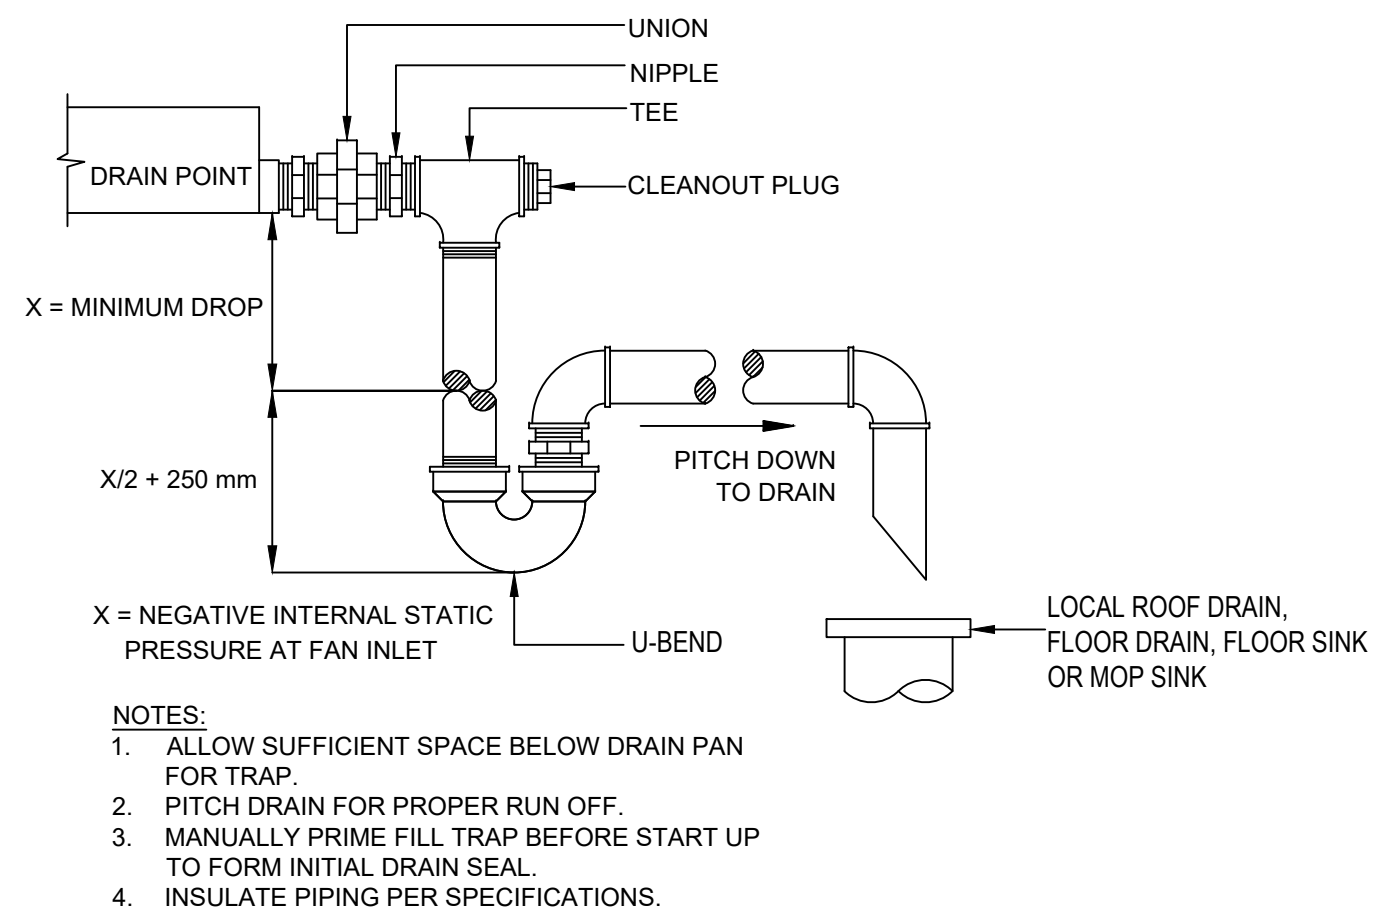


1 CONDENSATE DRAIN DETAIL
N.T.S.

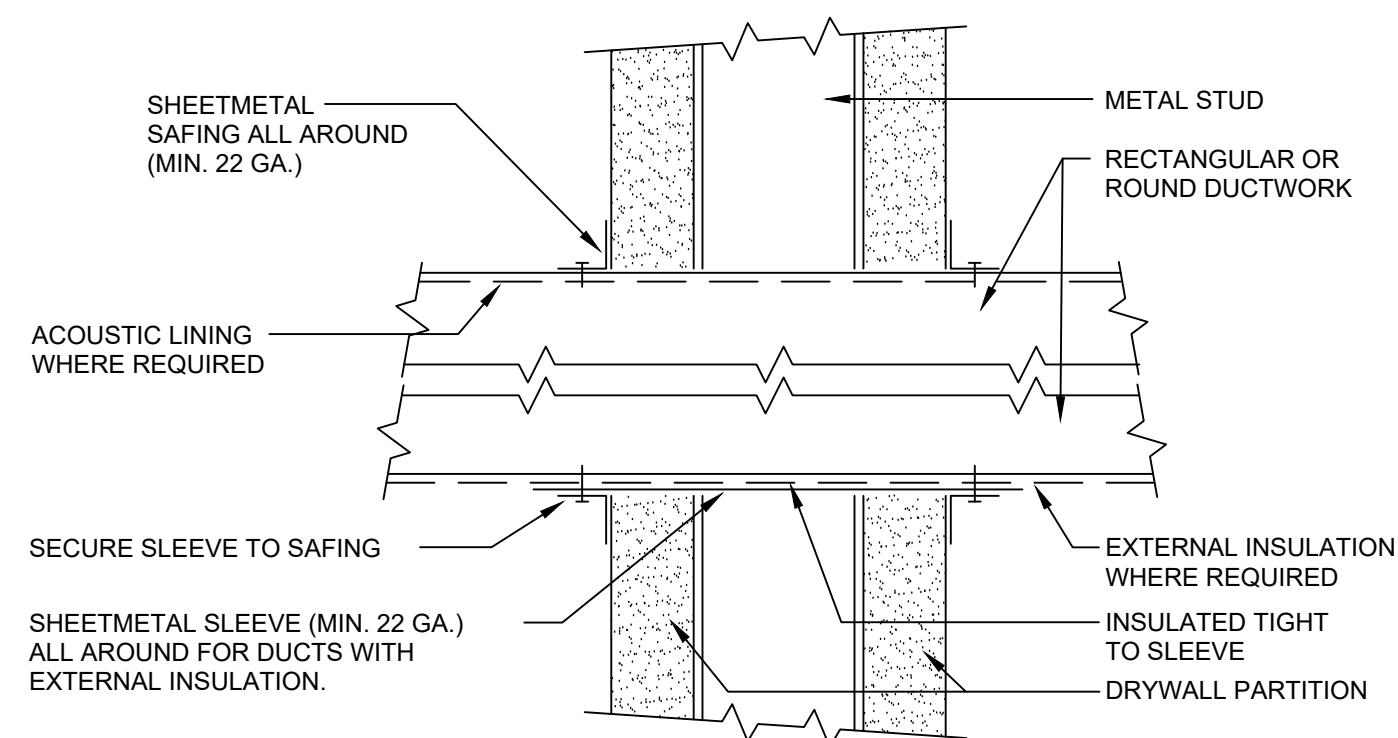

2 DUCT PENETRATION THROUGH NON-FIRE RATE WALL
N.T.S.

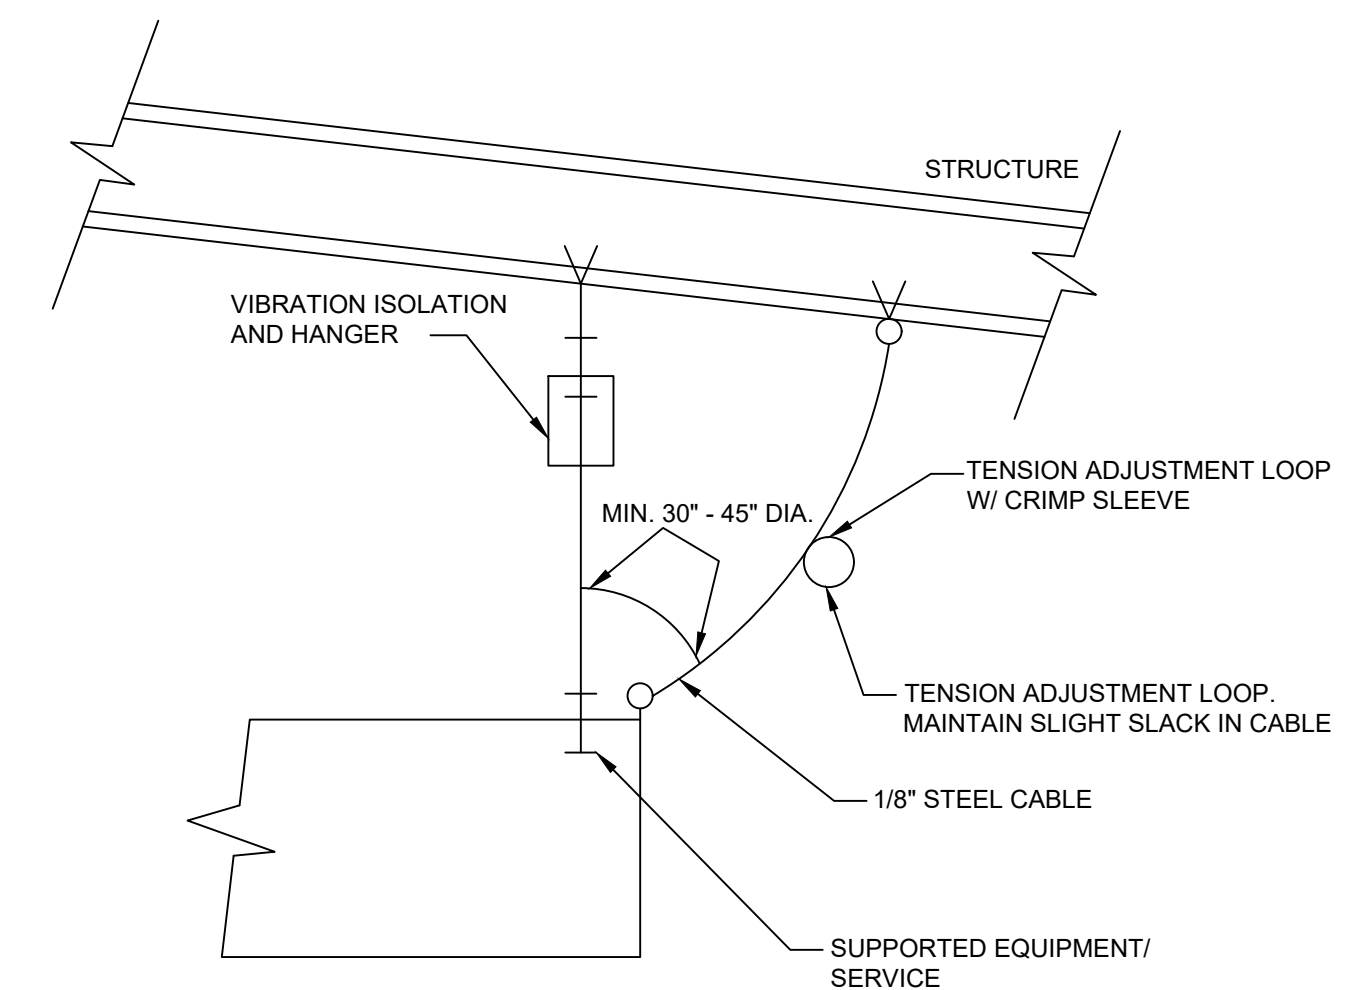


3 SEISMIC SWAY-BRACING DETAIL
N.T.S.

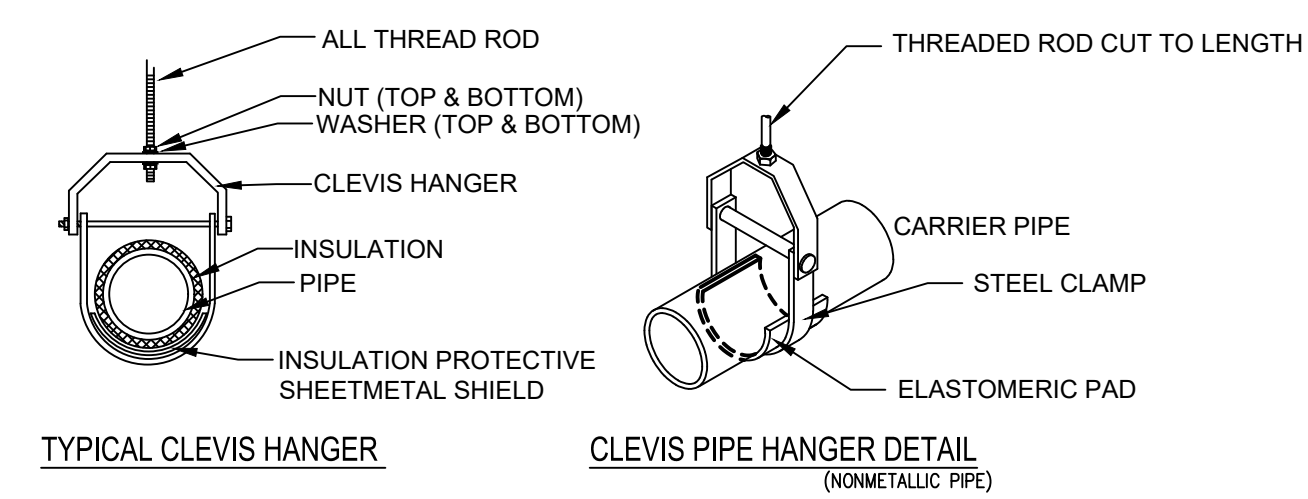

TYPICAL CLEVIS HANGER


CLEVIS PIPE HANGER DETAIL (NONMETALLIC PIPE)

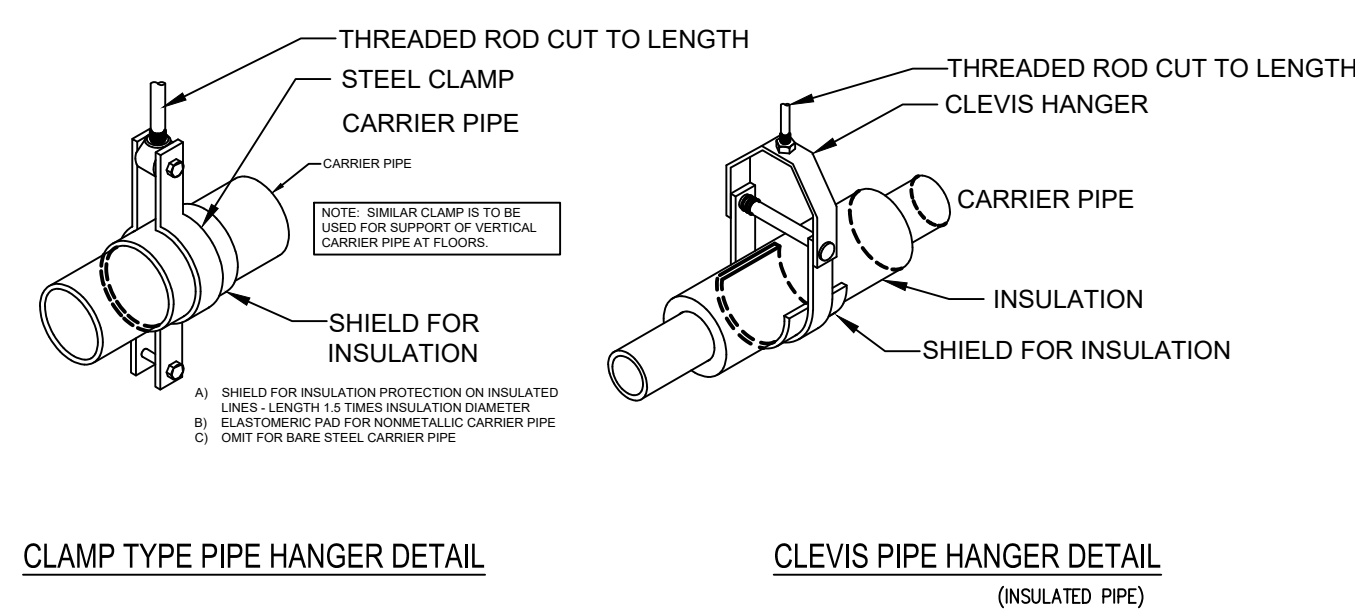


CLAMP TYPE PIPE HANGER DETAIL

CLEVIS PIPE HANGER DETAIL (INSULATED PIPE)

4 PIPE HANGER DETAILS
N.T.S.

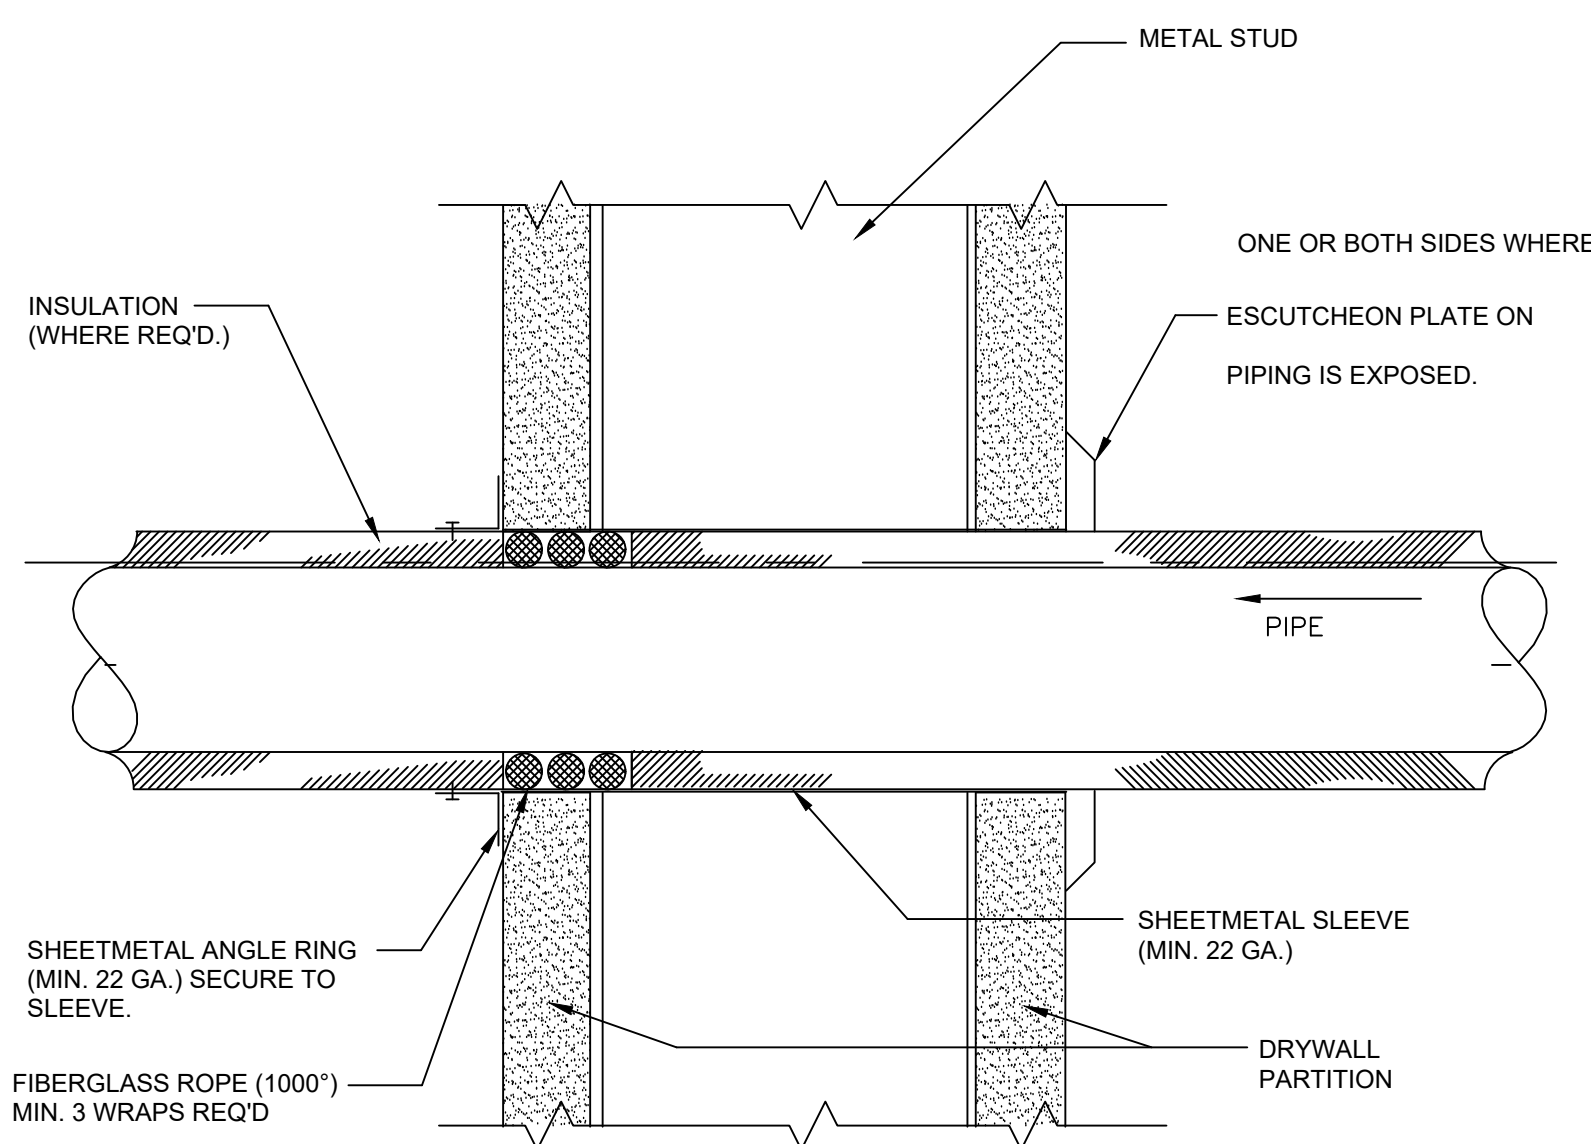


5 PIPE SLEEVE THROUGH WALL DETAIL
N.T.S.

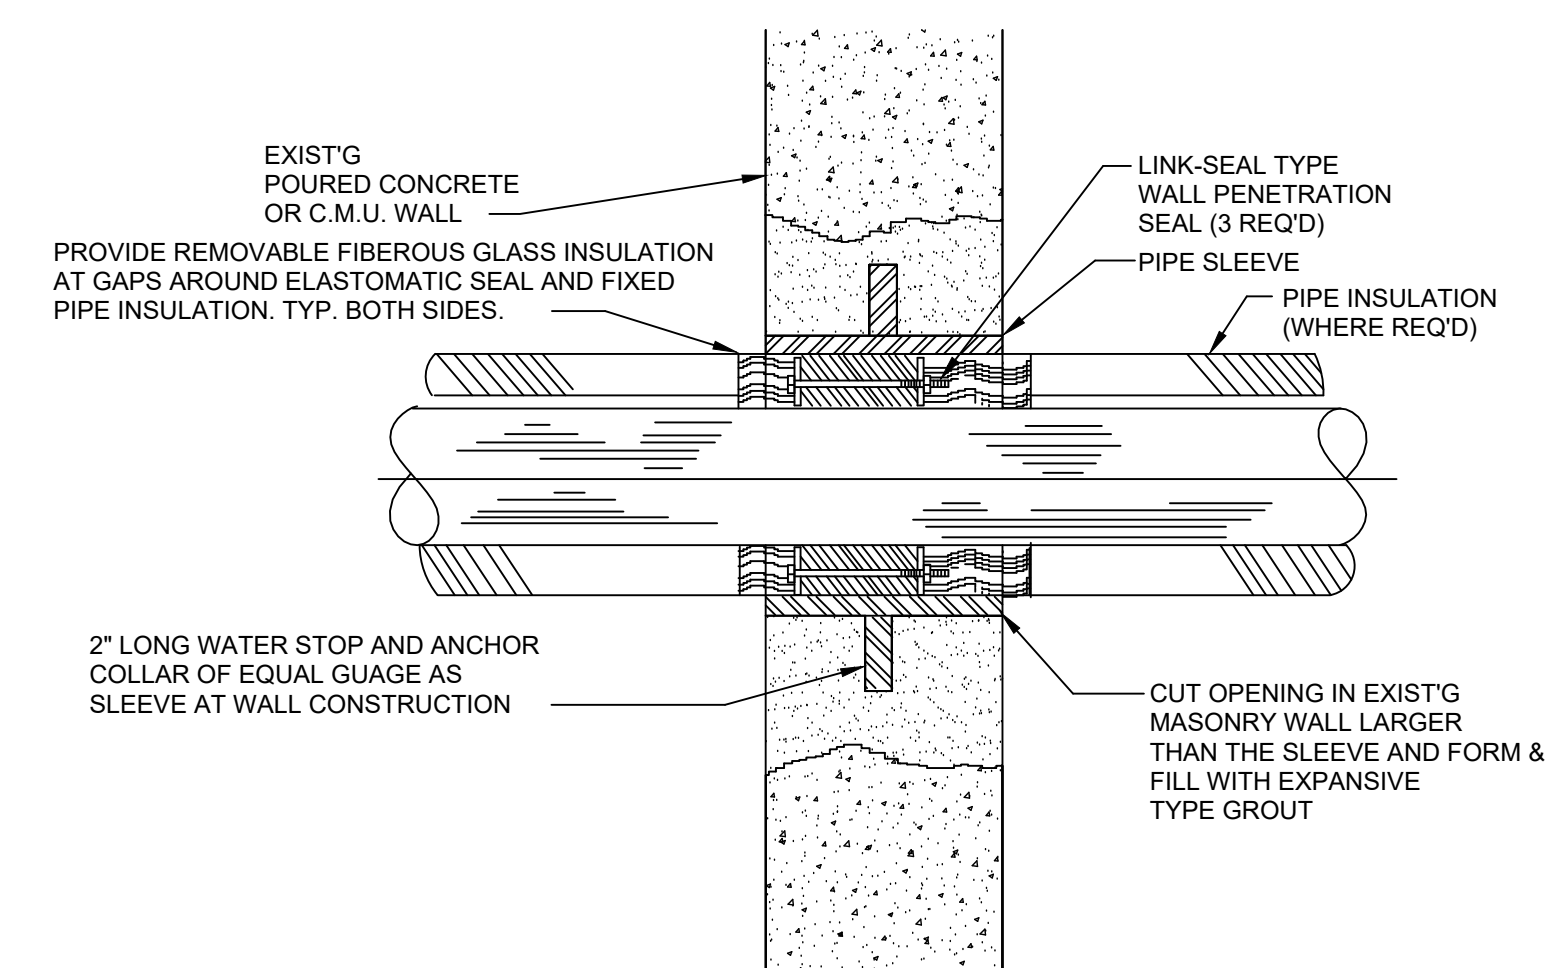

6 PIPE SLEEVE THROUGH WALL DETAIL
N.T.S.



JTK ENGINEERING
HVAC | PLUMBING | ENERGY
WWW.JTKENG.COM

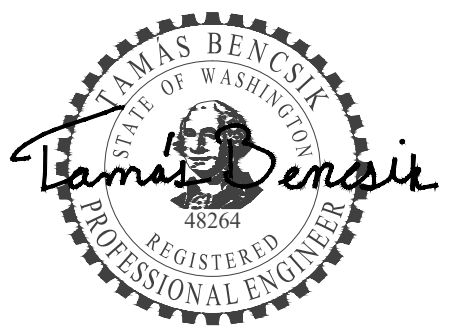

February 15, 2025



CARLETTI ARCHITECTS P.S.
116 EAST FR STREET
SUITE A
MOUNT VERNON, WA 98273
Phone: (360) 434-0384
Fax: (360) 424-3726



**SKAGIT COUNTY
CONCRETE COMMUNITY
CENTER**

REVISIONS

stage: **BID SET**

client: **CARLETTI ARCHITECTS**

project: **CONCRETE COMMUNITY CENTER
45821 RAILROAD AVE
CONCRETE,
WASHINGTON**

drawn by: **NH**

original sheet size: **24x36**

revision: **None**

date: **2025.02.18**

scale:


DETAILS

sheet.

M3.1



JTK ENGINEERING
HVAC | PLUMBING | ENERGY
WWW.JTKENG.COM

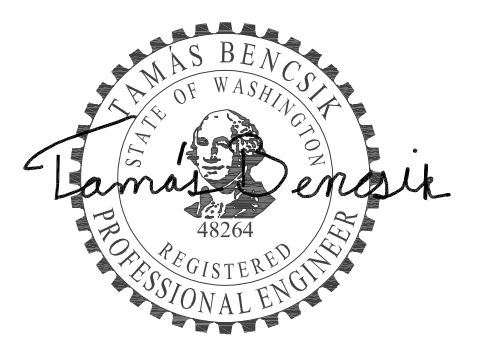

February 15, 2025



**SKAGIT COUNTY
CONCRETE COMMUNITY
CENTER**

REVISIONS

NO.	DATE	DESCRIPTION

stage: **BID SET**

client: **CARLETTI ARCHITECTS**

project: **CONCRETE COMMUNITY CENTER
45821 RAILROAD AVE
CONCRETE,
WASHINGTON**

drawn by: **NH**

original sheet size: **24x36**

revision: **None**






date: **2025.02.18**

scale:

DETAILS

sheet:

M3.2

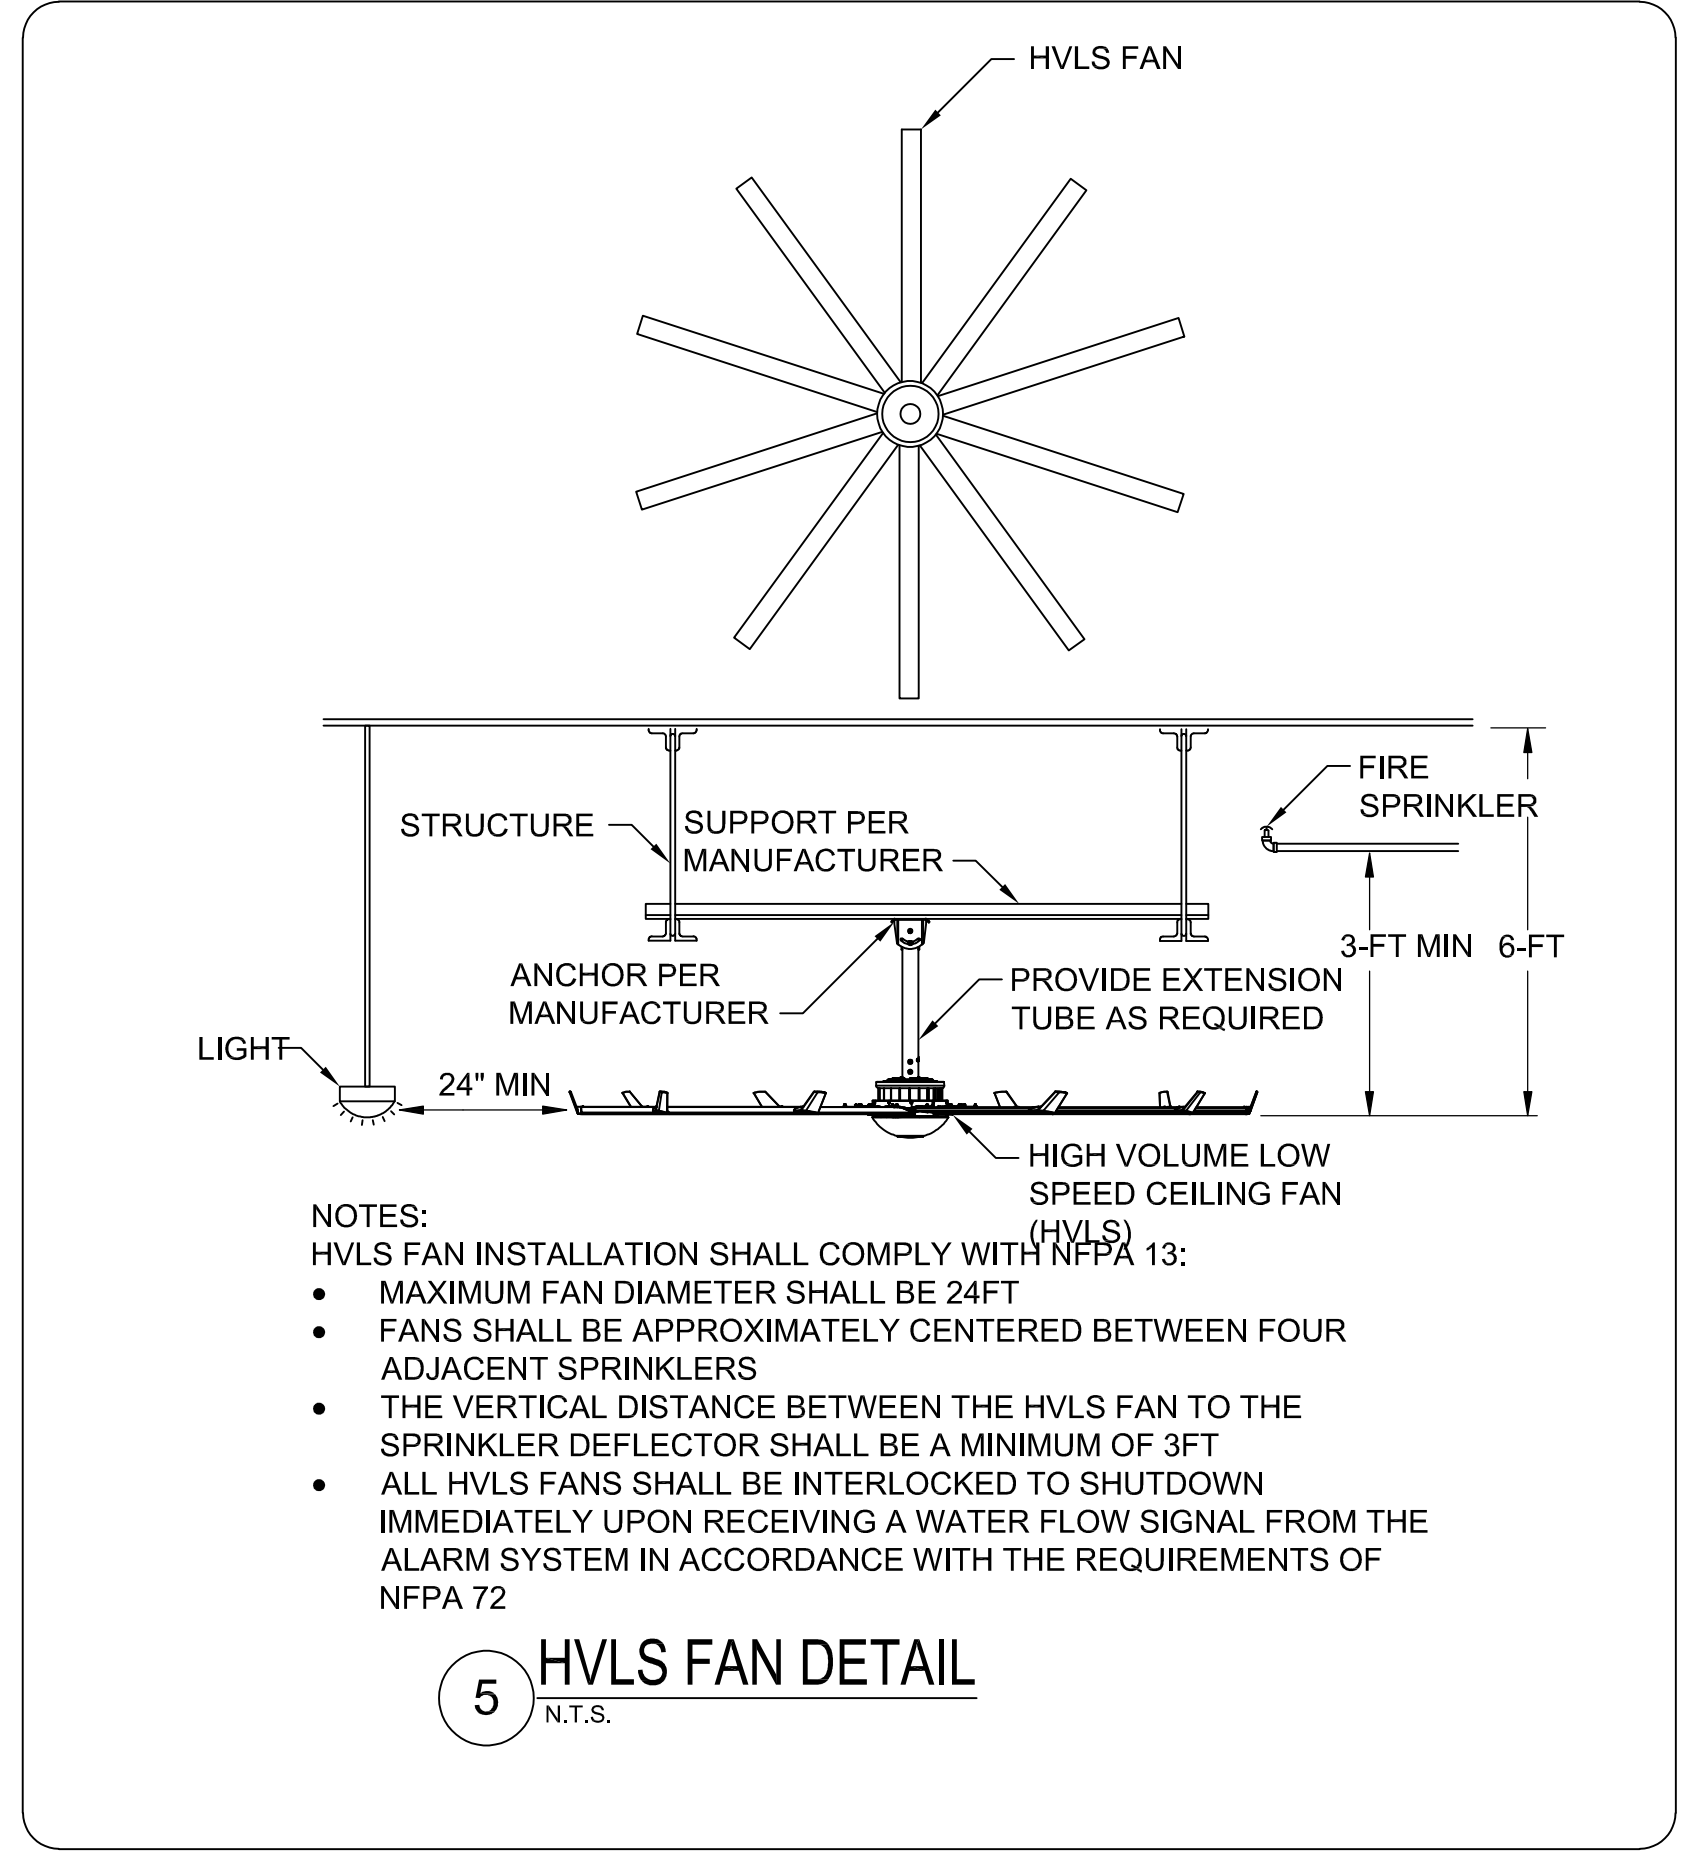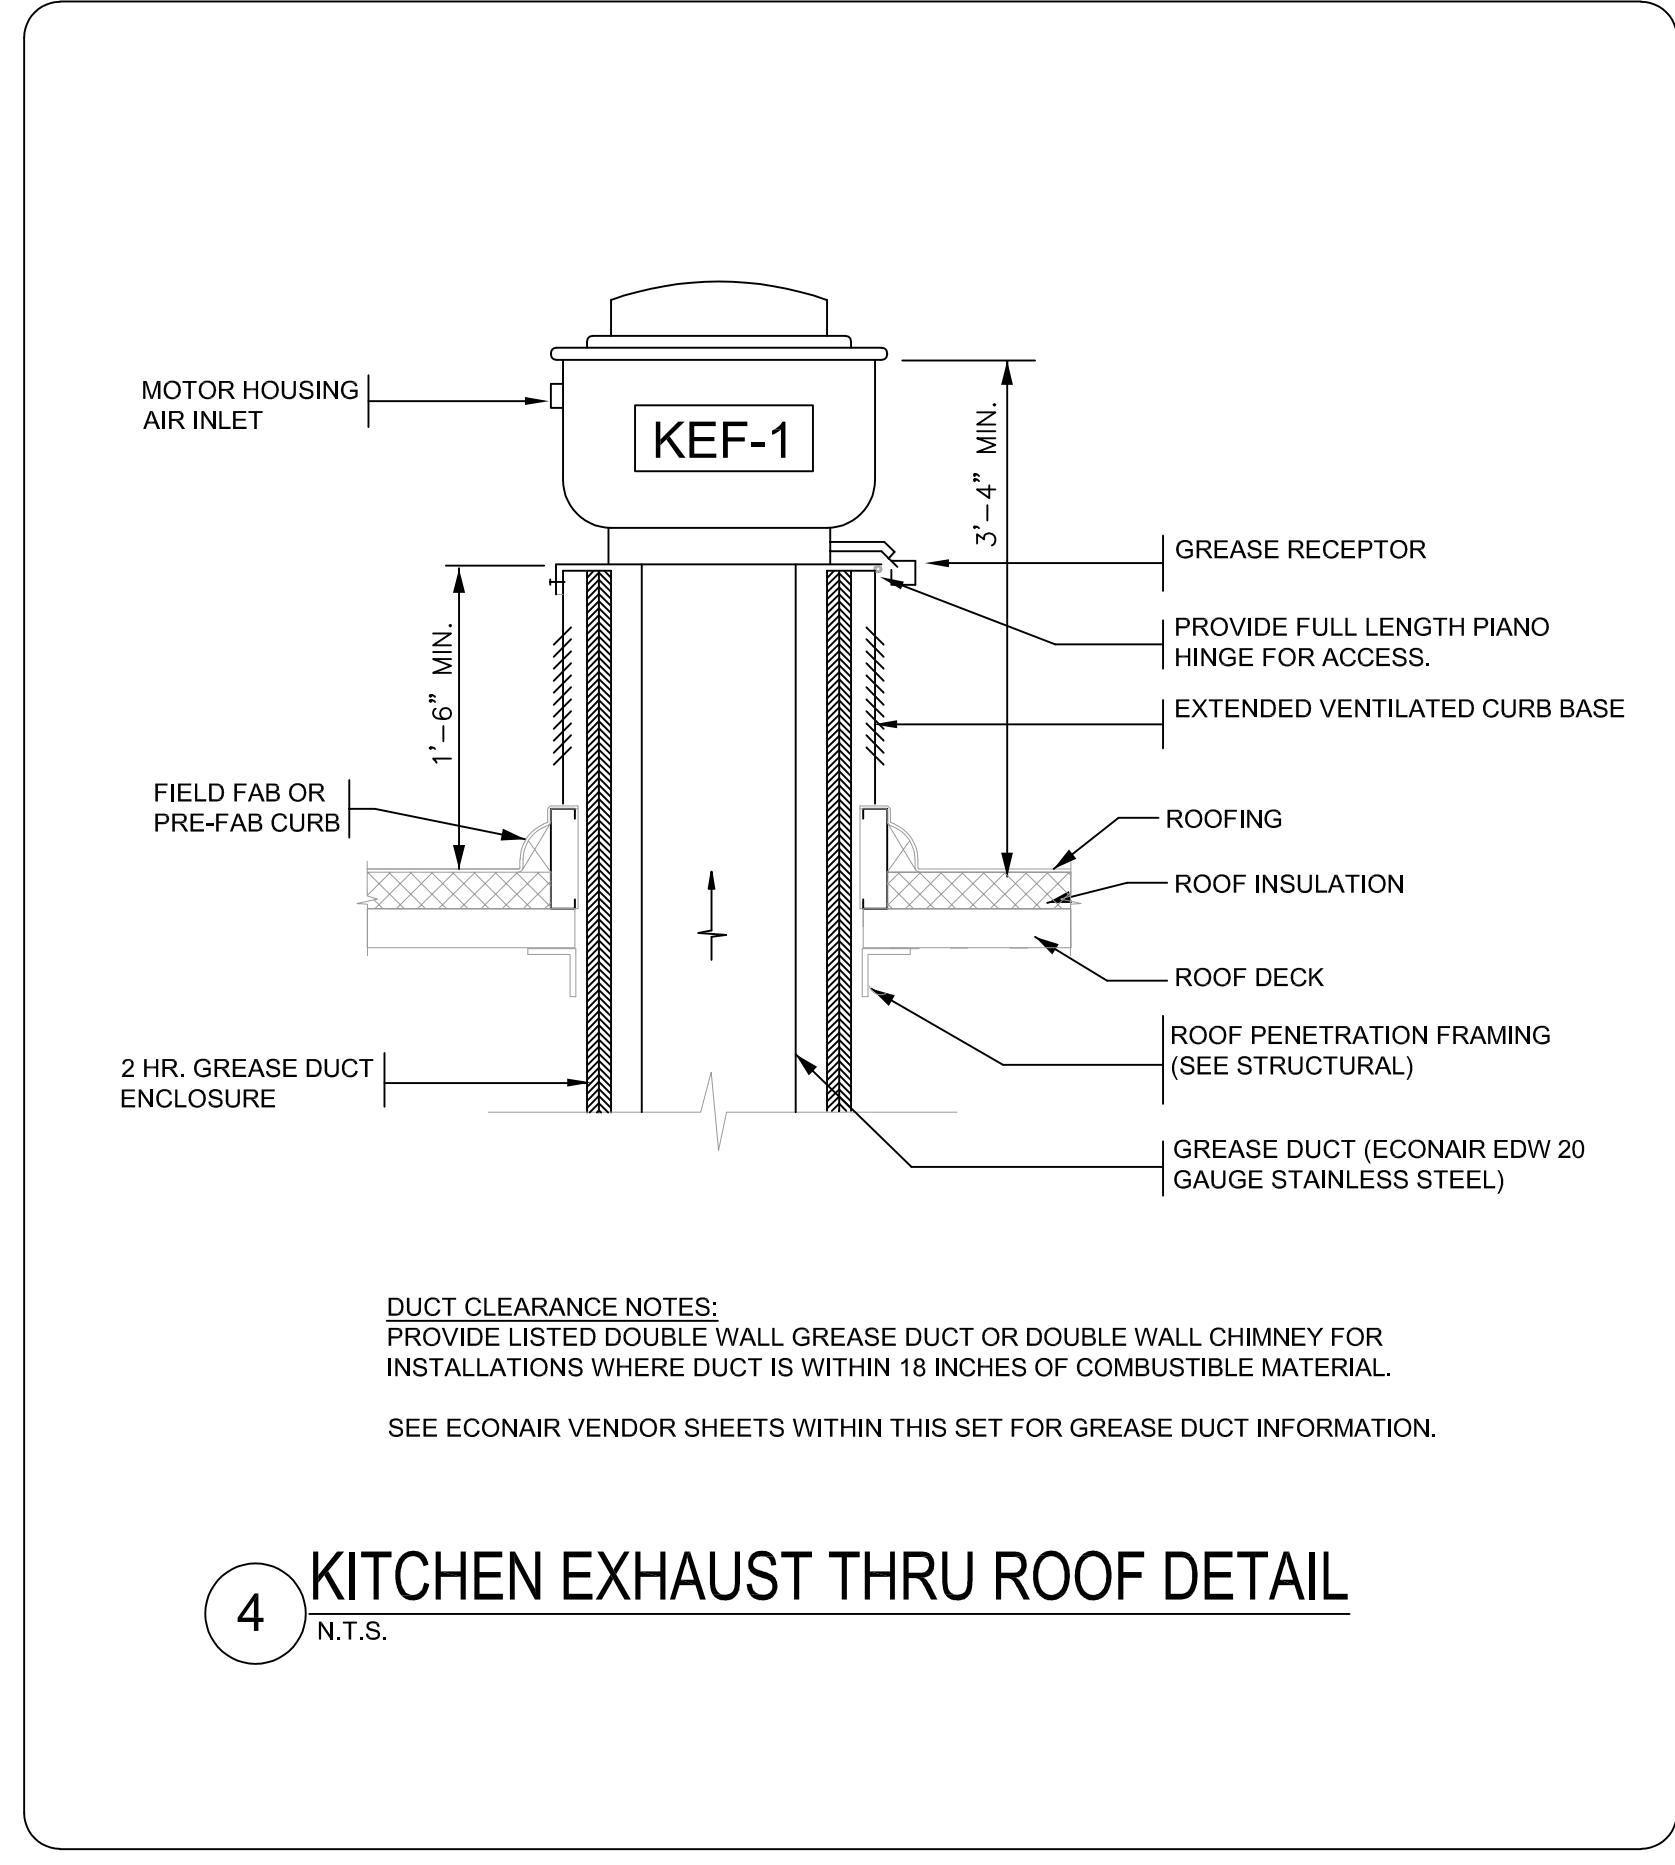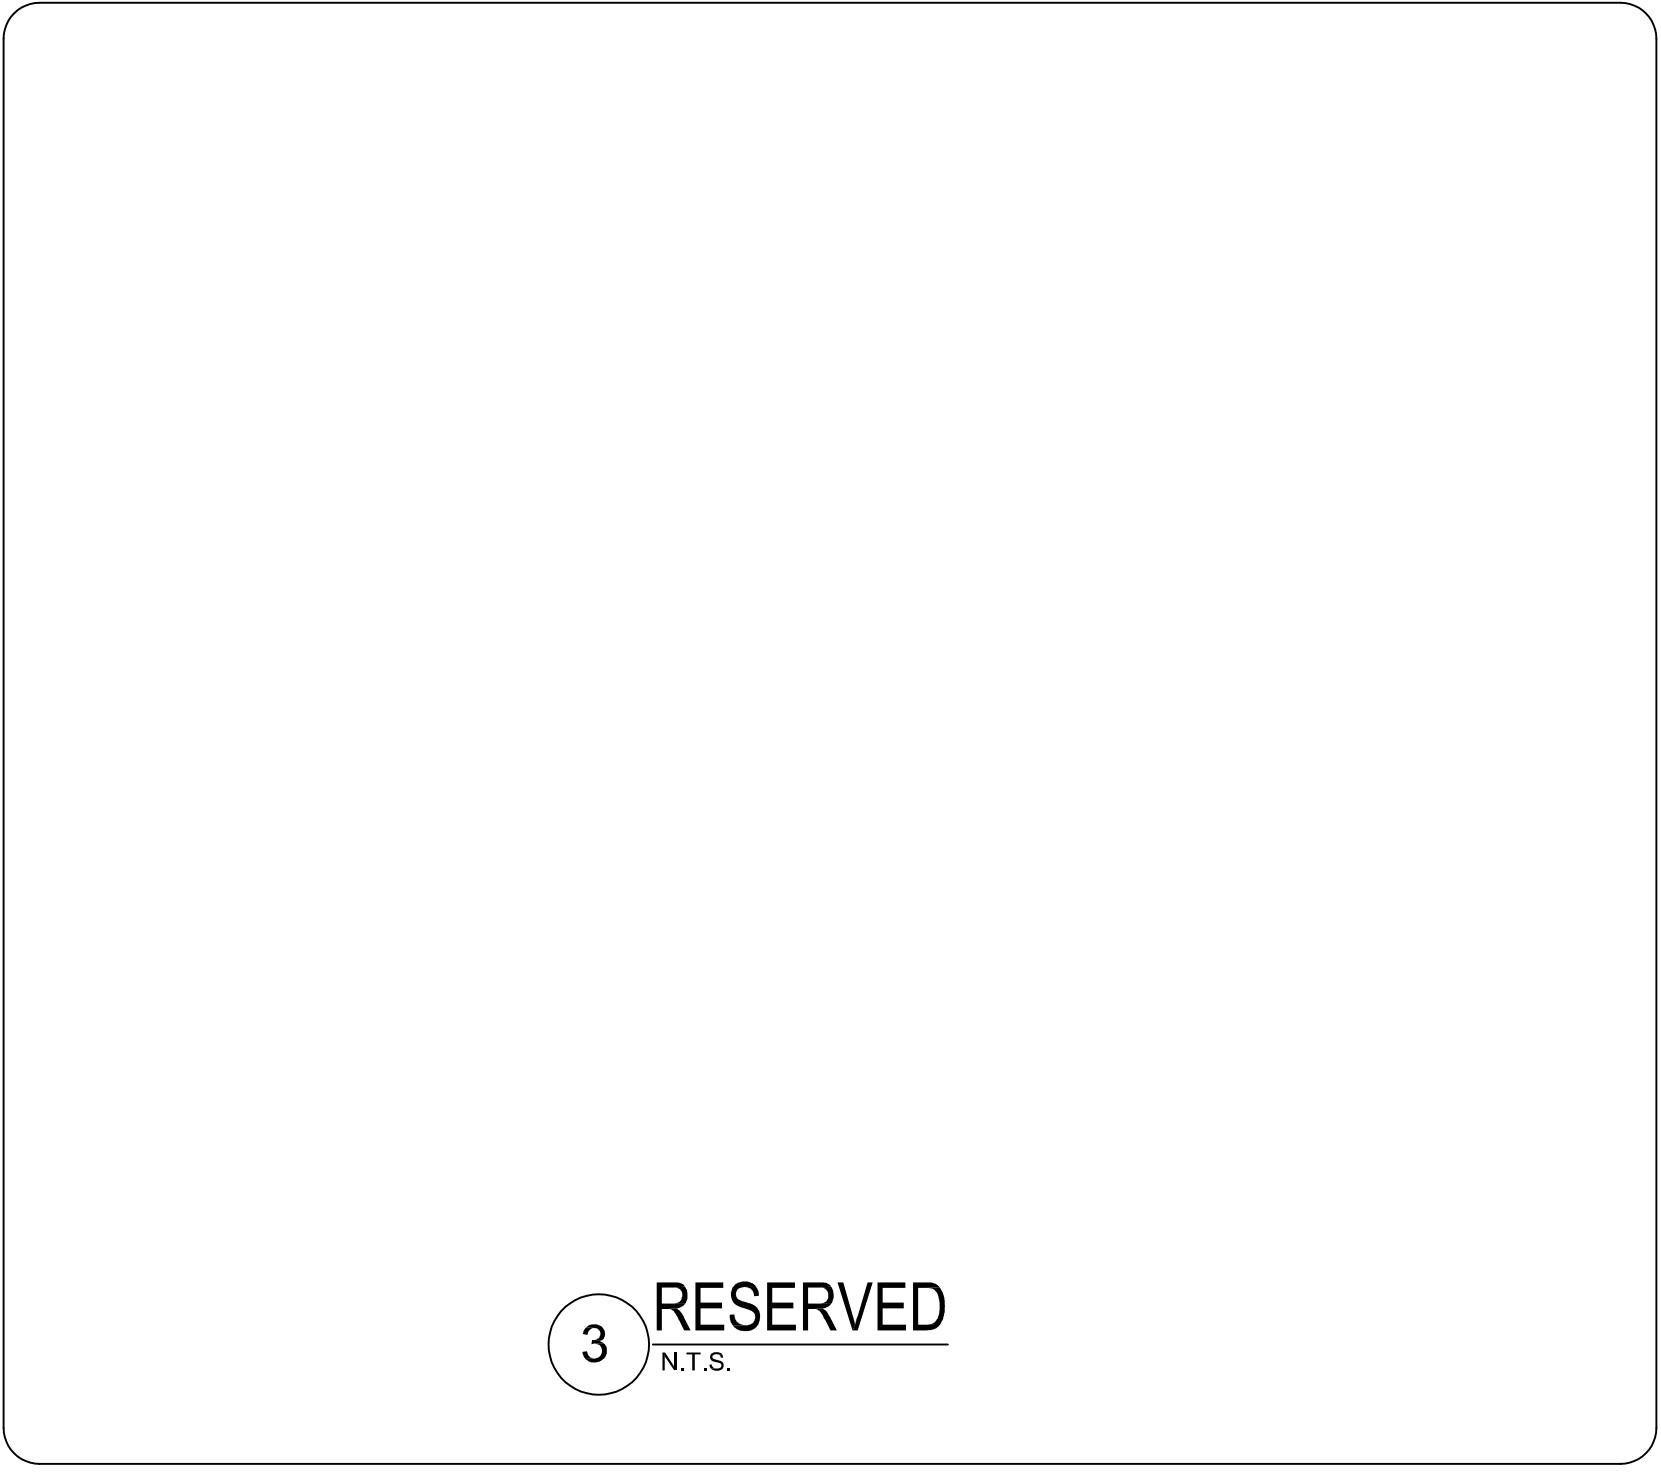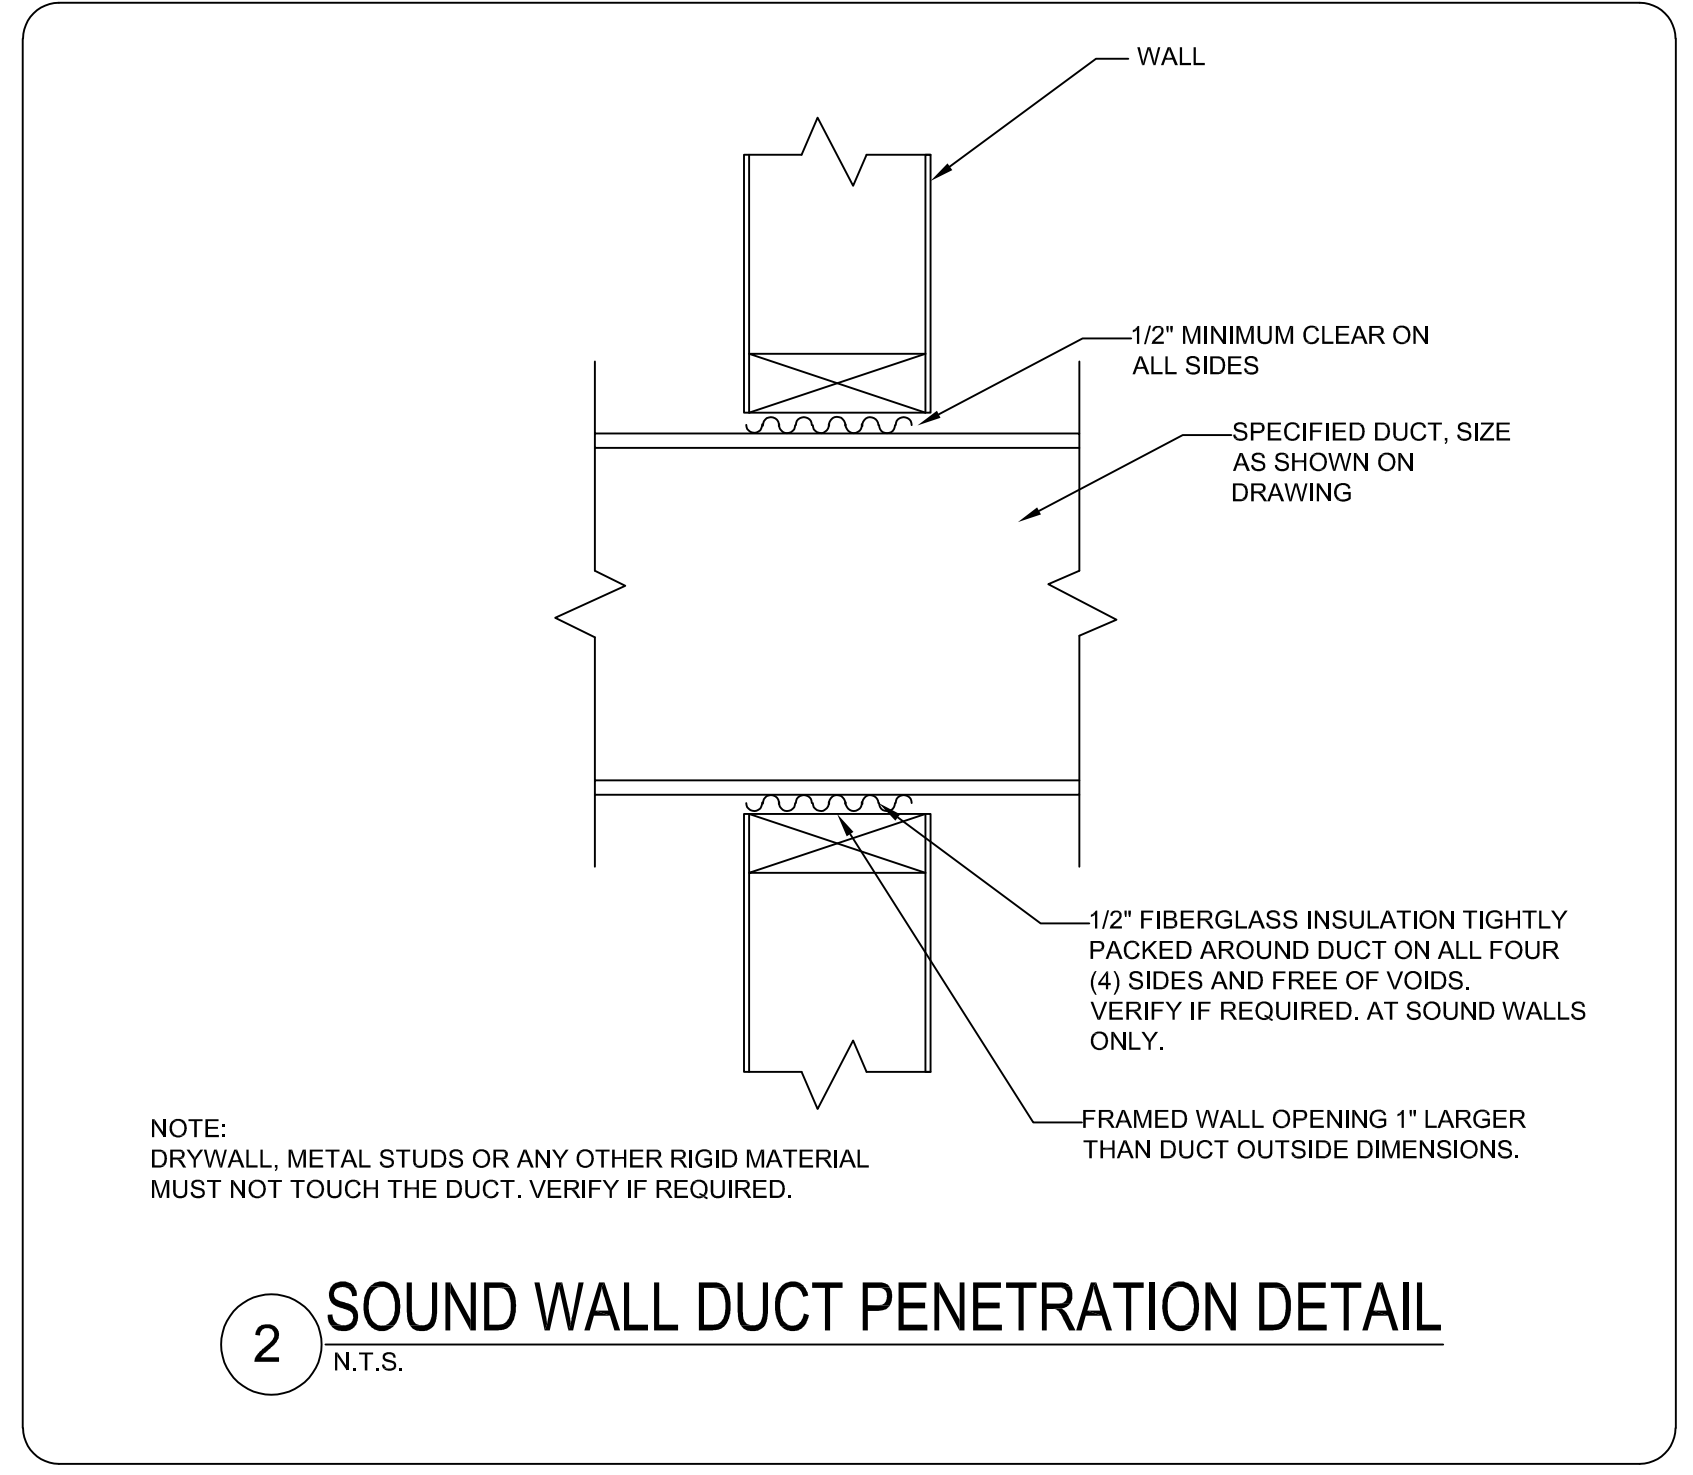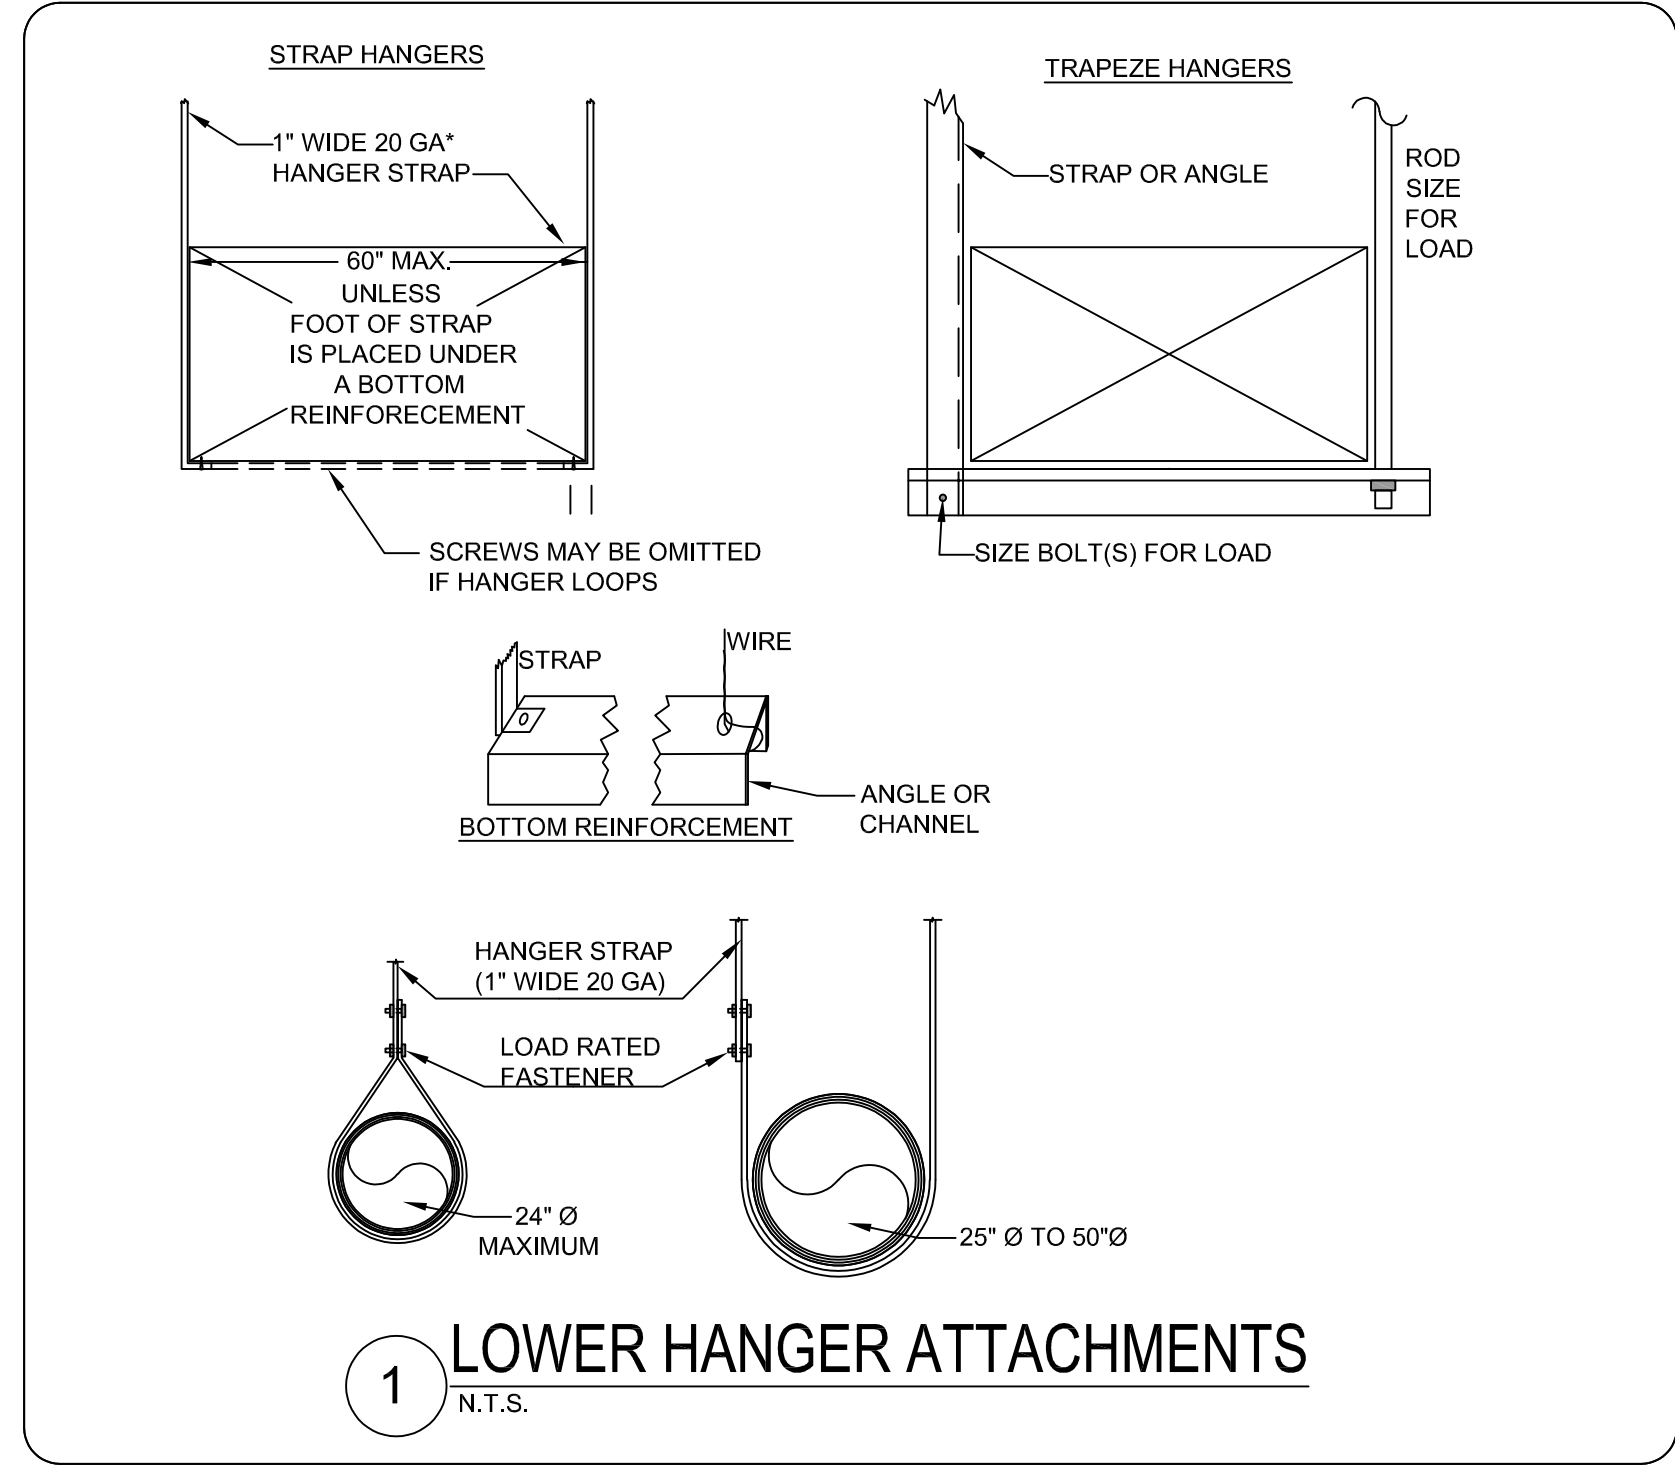



JTK ENGINEERING
HVAC | PLUMBING | ENERGY
WWW.JTKENG.COM



February 15, 2025

CARLETTI ARCHITECTS P.S.
ARCHITECTS, DESIGN & MORE
116 EAST FIR STREET
SUITE A
MOUNT VERNON, WA 98273
Phone: (360) 434-0384
Fax: (360) 424-3726



SKAGIT COUNTY CONCRETE COMMUNITY CENTER

REVISIONS

stage: **BID SET**

client: **CARLETTI ARCHITECTS**

project: **CONCRETE COMMUNITY CENTER
45821 RAILROAD AVE
CONCRETE,
WASHINGTON**

drawn by: **NH**

original sheet size: **24x36**

revision: **None**

date: **2025.02.18**

scale:







CONTROLS

sheet:

M4.0

HVAC CONTROL SYMBOLS			
SYMBOL	DESCRIPTION	SYMBOL	DESCRIPTION
	GATE VALVE		ROOM OR ZONE THERMOSTAT, MISC SENSOR
	GLOBE VALVE		DUCT THERMOSTAT
	GAS COCK		THERMOMETER
	SOLENOID VALVE		EXPANSION VALVE
	CONTROL VALVE, 2-WAY		DAMPER MOTOR
	PRESSURE REDUCING VALVE		DAMPER
	CHECK VALVE		MOTOR
	CENTRIFUGAL FAN PLUG FAN		PLUG VALVE
	FLOW SWITCH		PRESSURE GAGE
	FIRE SAFETY SWITCH		PRESSURE SWITCH
	HUMIDISTAT, ROOM		PUMP
	HUMIDISTAT, DUCT		RELAY
	BALL VALVE		PRESS./TEMP. RELIEF VALVE
	CONTROL VALVE, 3-WAY		SMOKE DETECTOR
	FLOW SWITCH		CONTROL WIRING
	STEAM TRAP		STATIC PRESSURE CONTROLLER


NOTES:
1. CONTRACTOR SHALL PROVIDE ALL PROGRAMMING, LABOR, INTERFACE/INTEGRATION DEVICES AND MATERIALS FOR A FULLY OPERATIONAL CONTROLS SYSTEM.
2. PROVIDE CONTROLS FLOOR PLANS, DRAWINGS, PROGRAMMING AND PRODUCT SUBMITTALS TO ENGINEERING FOR REVIEW.

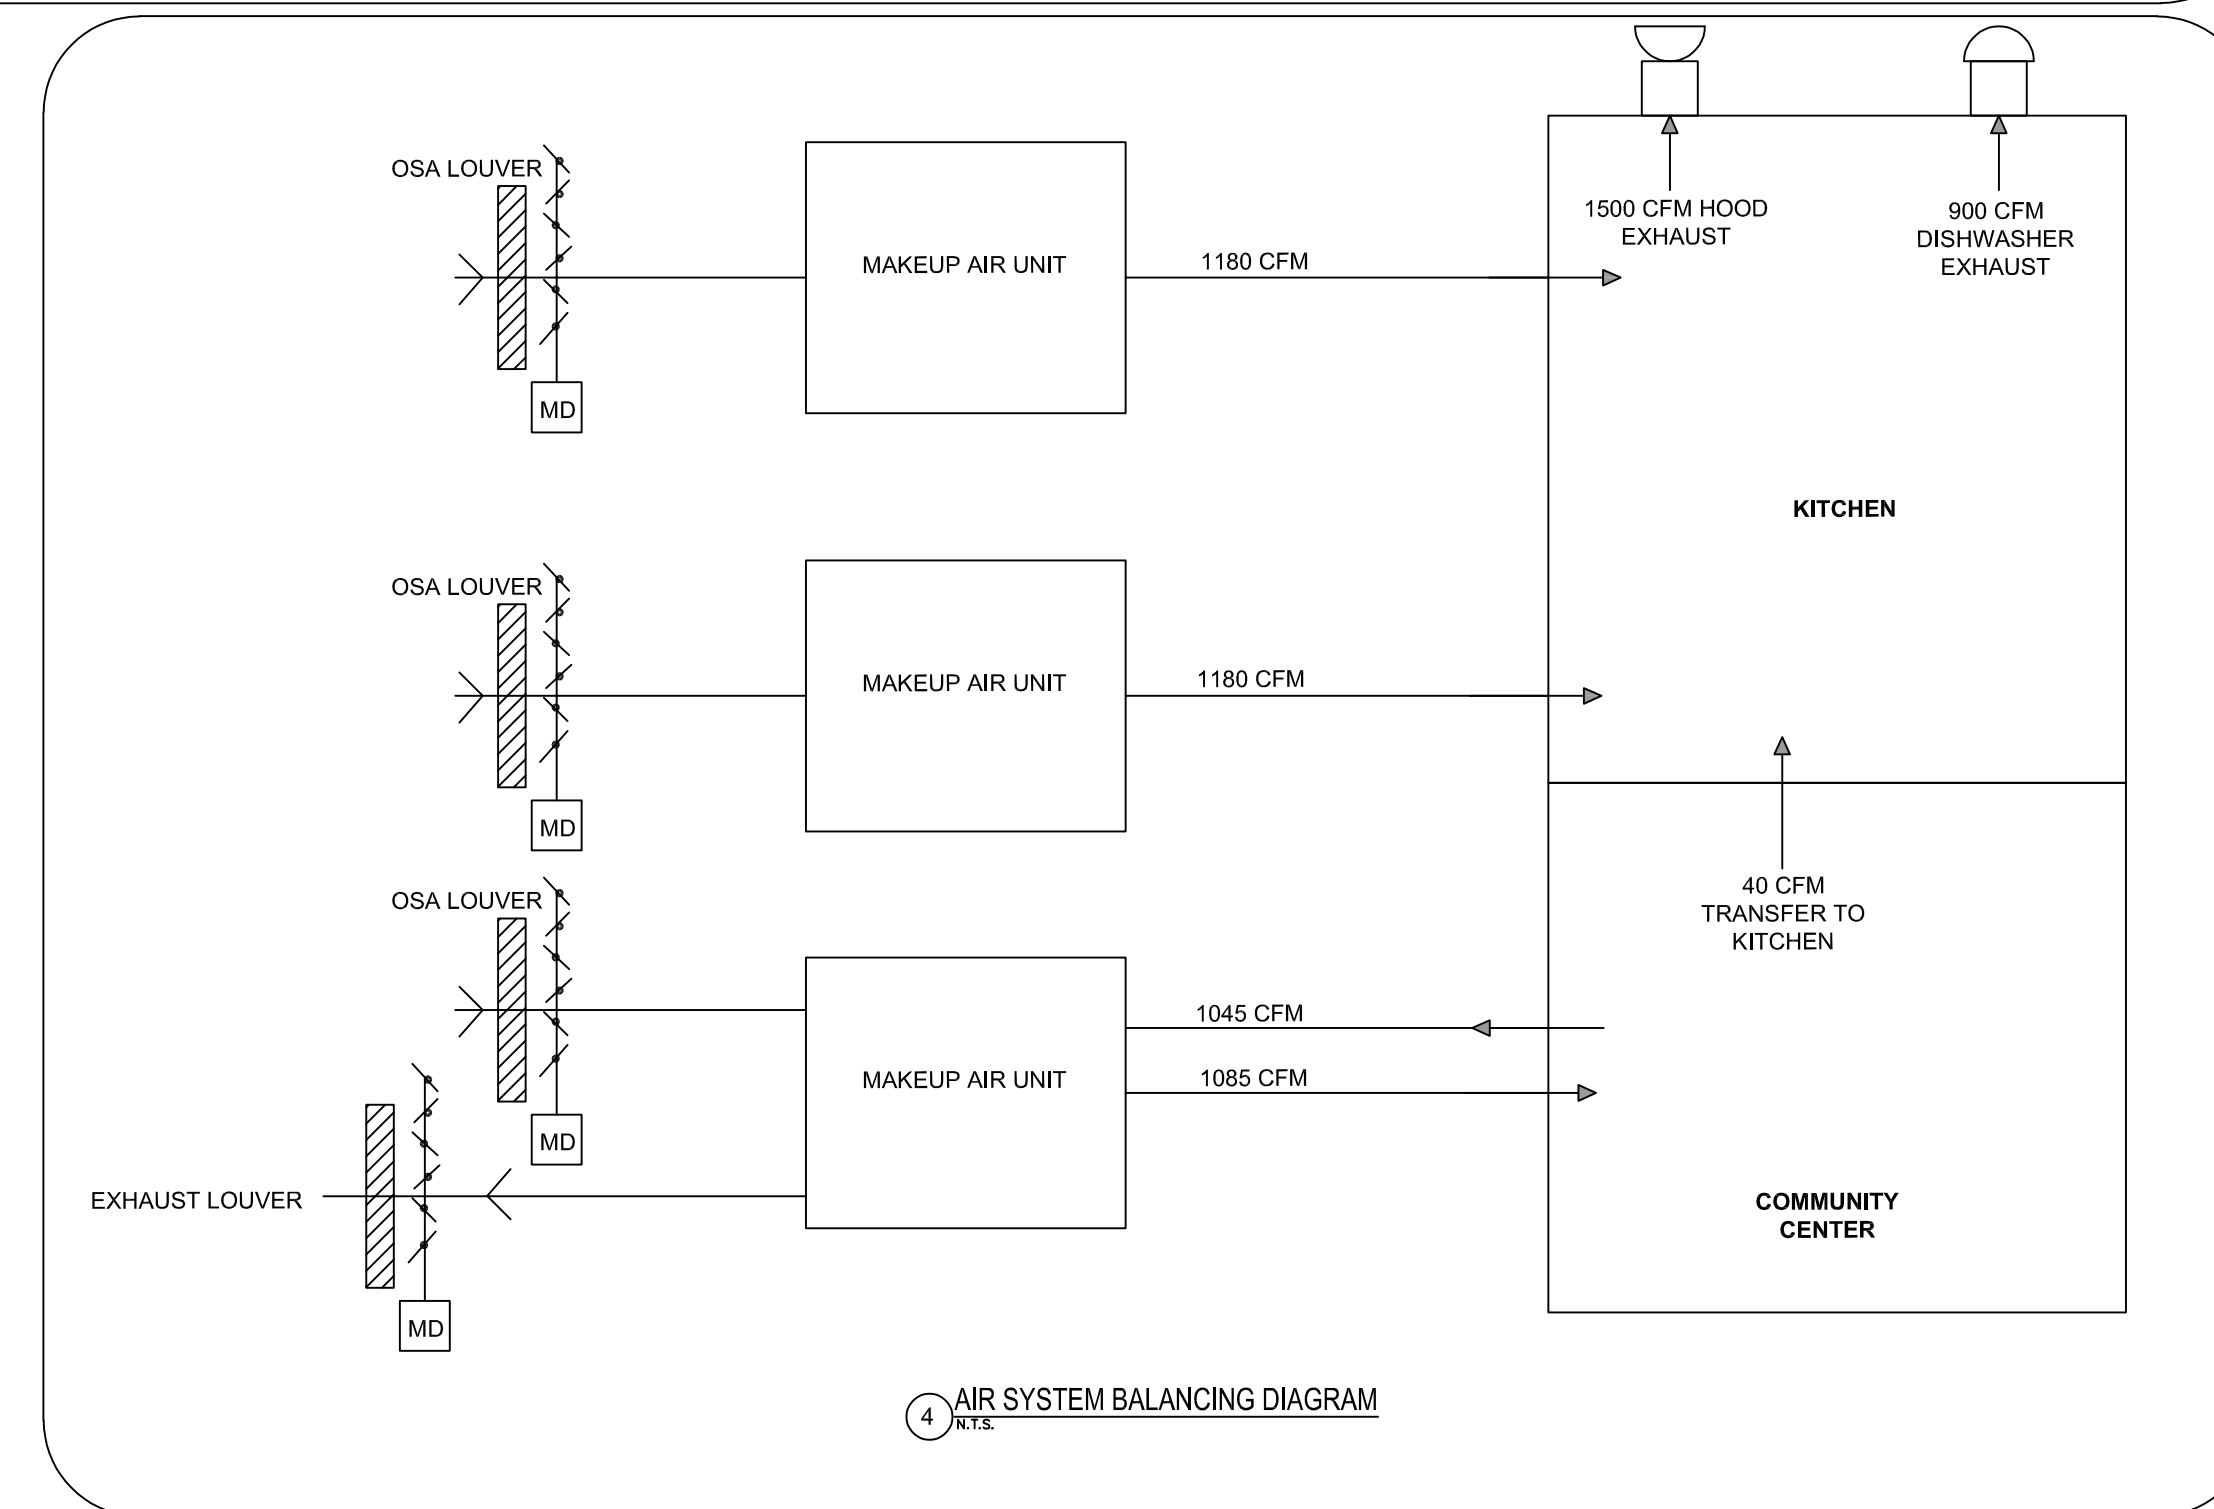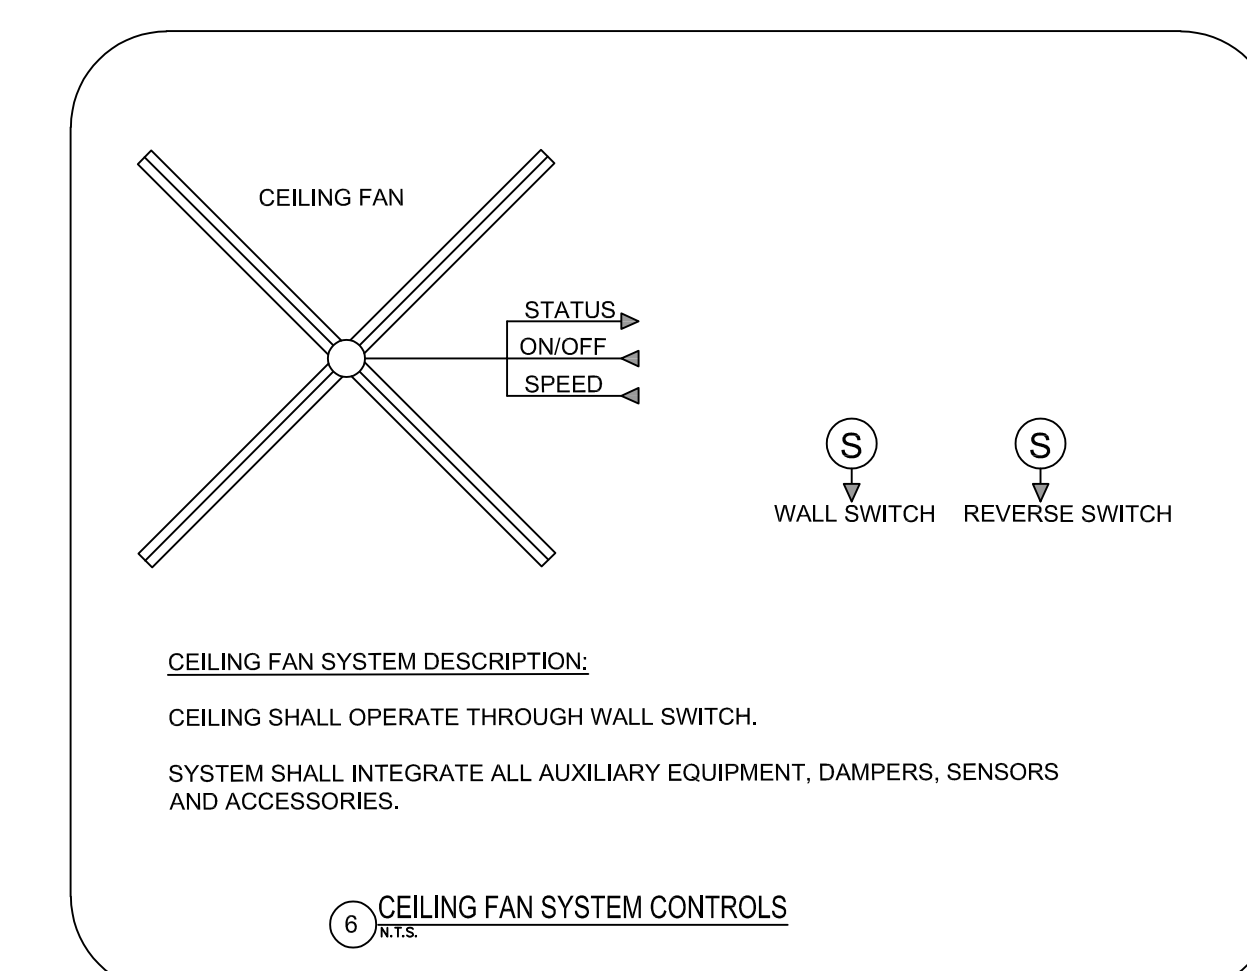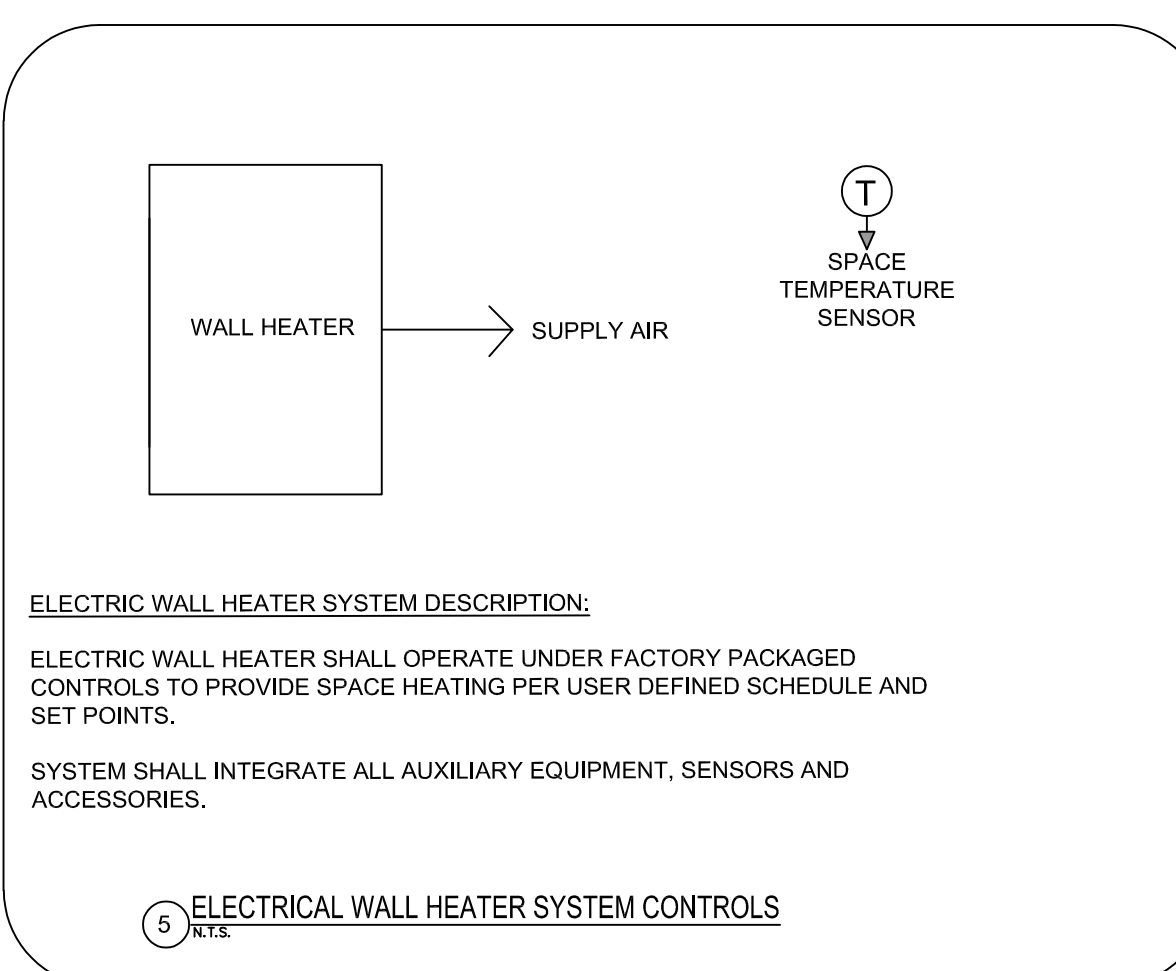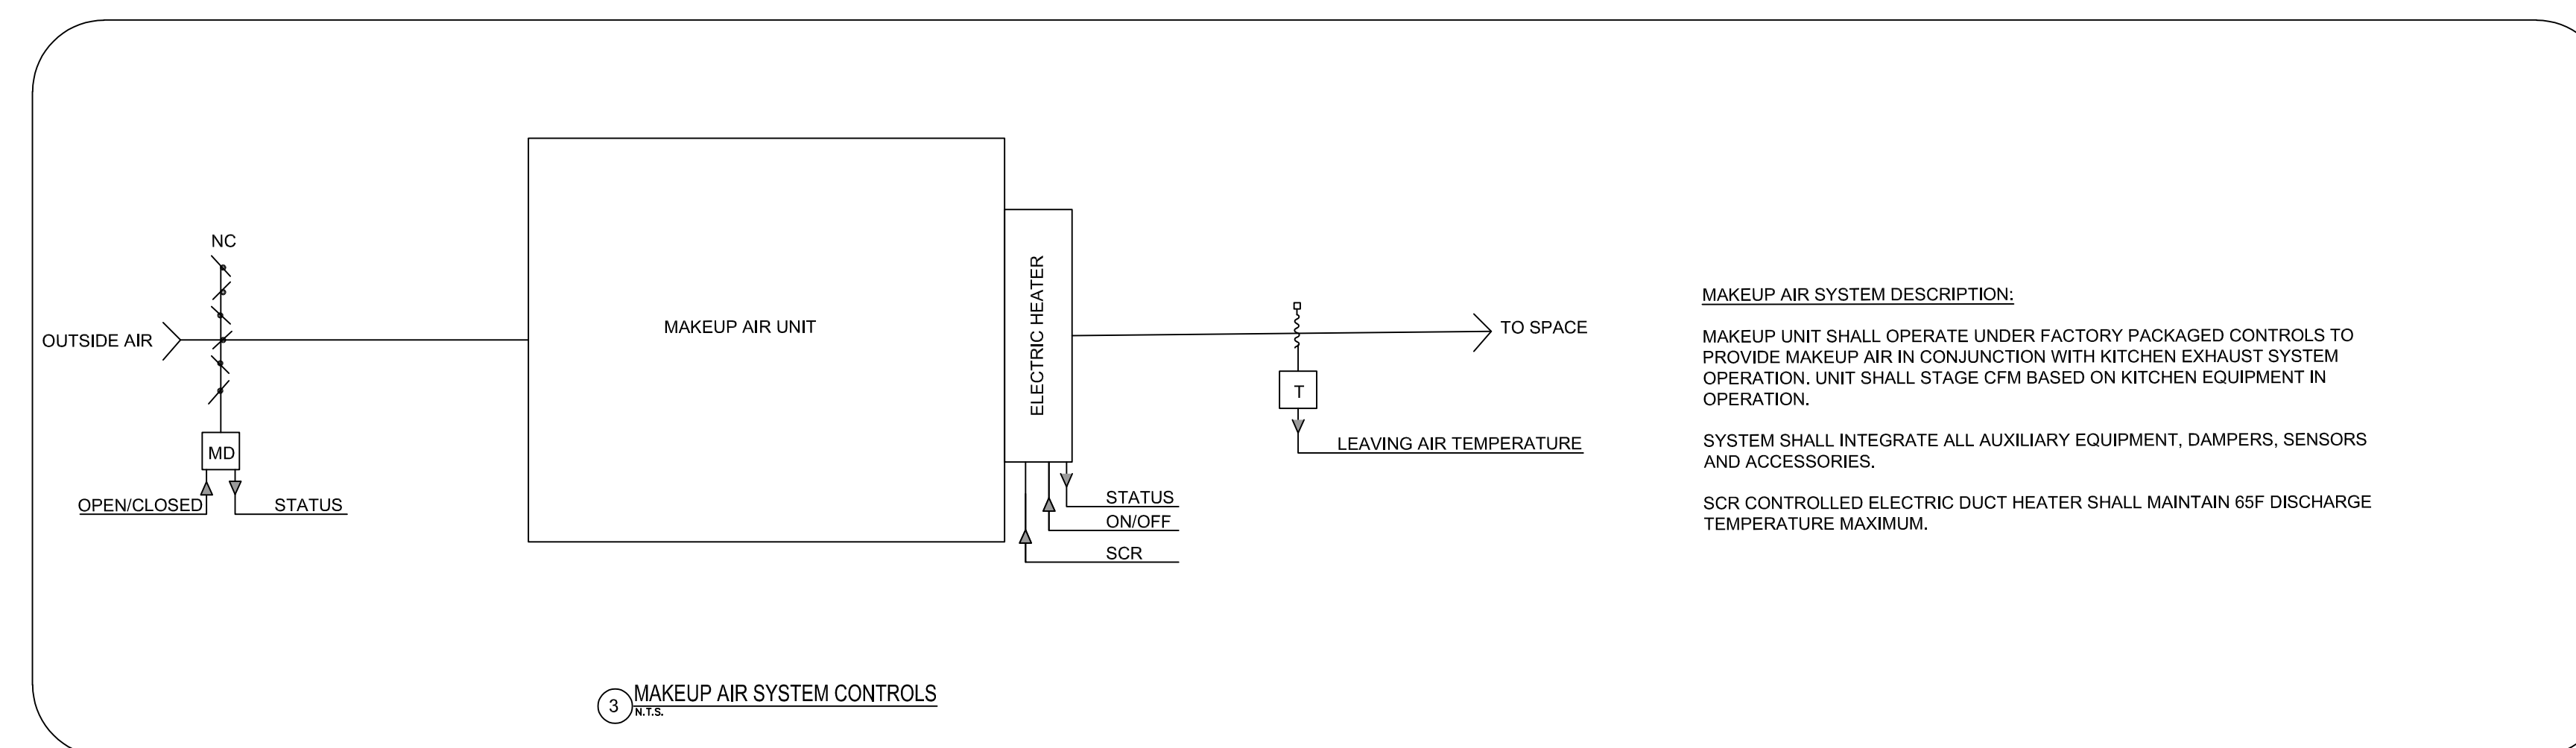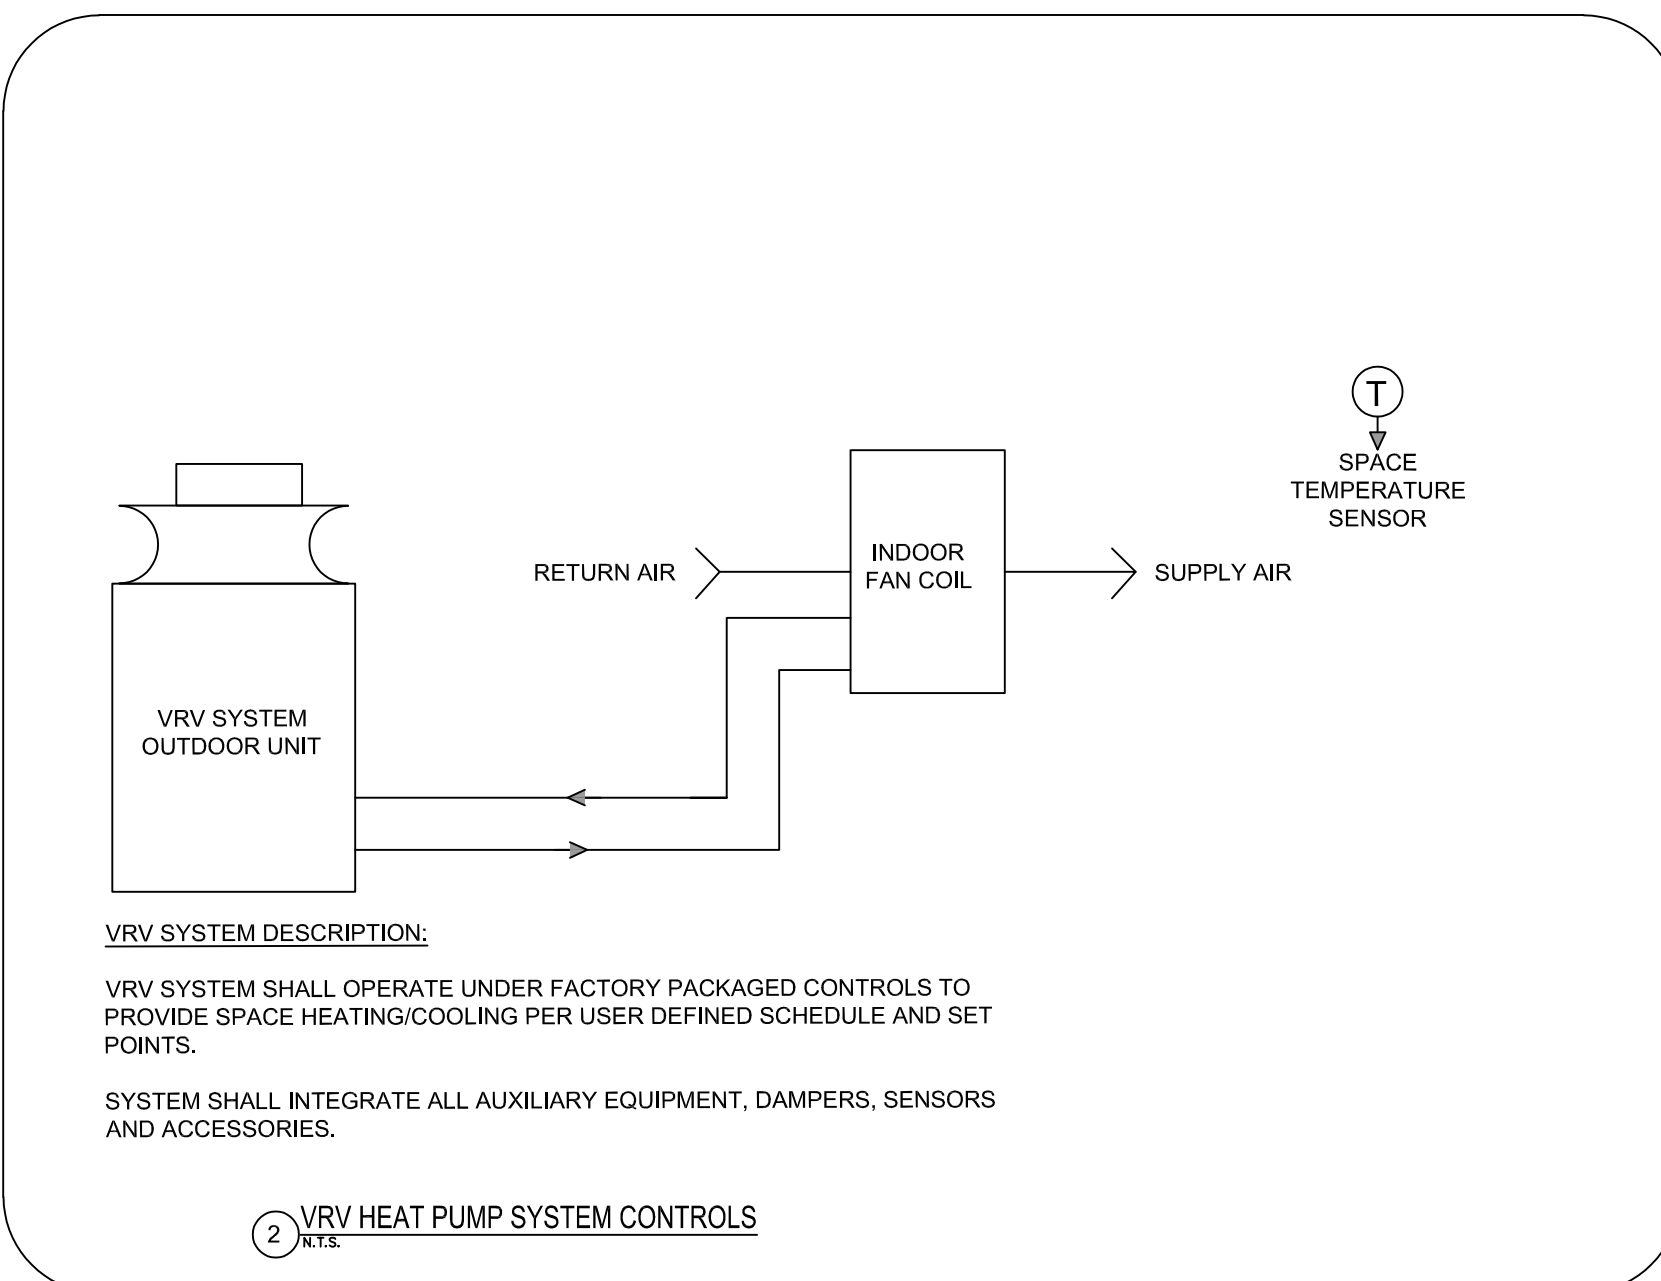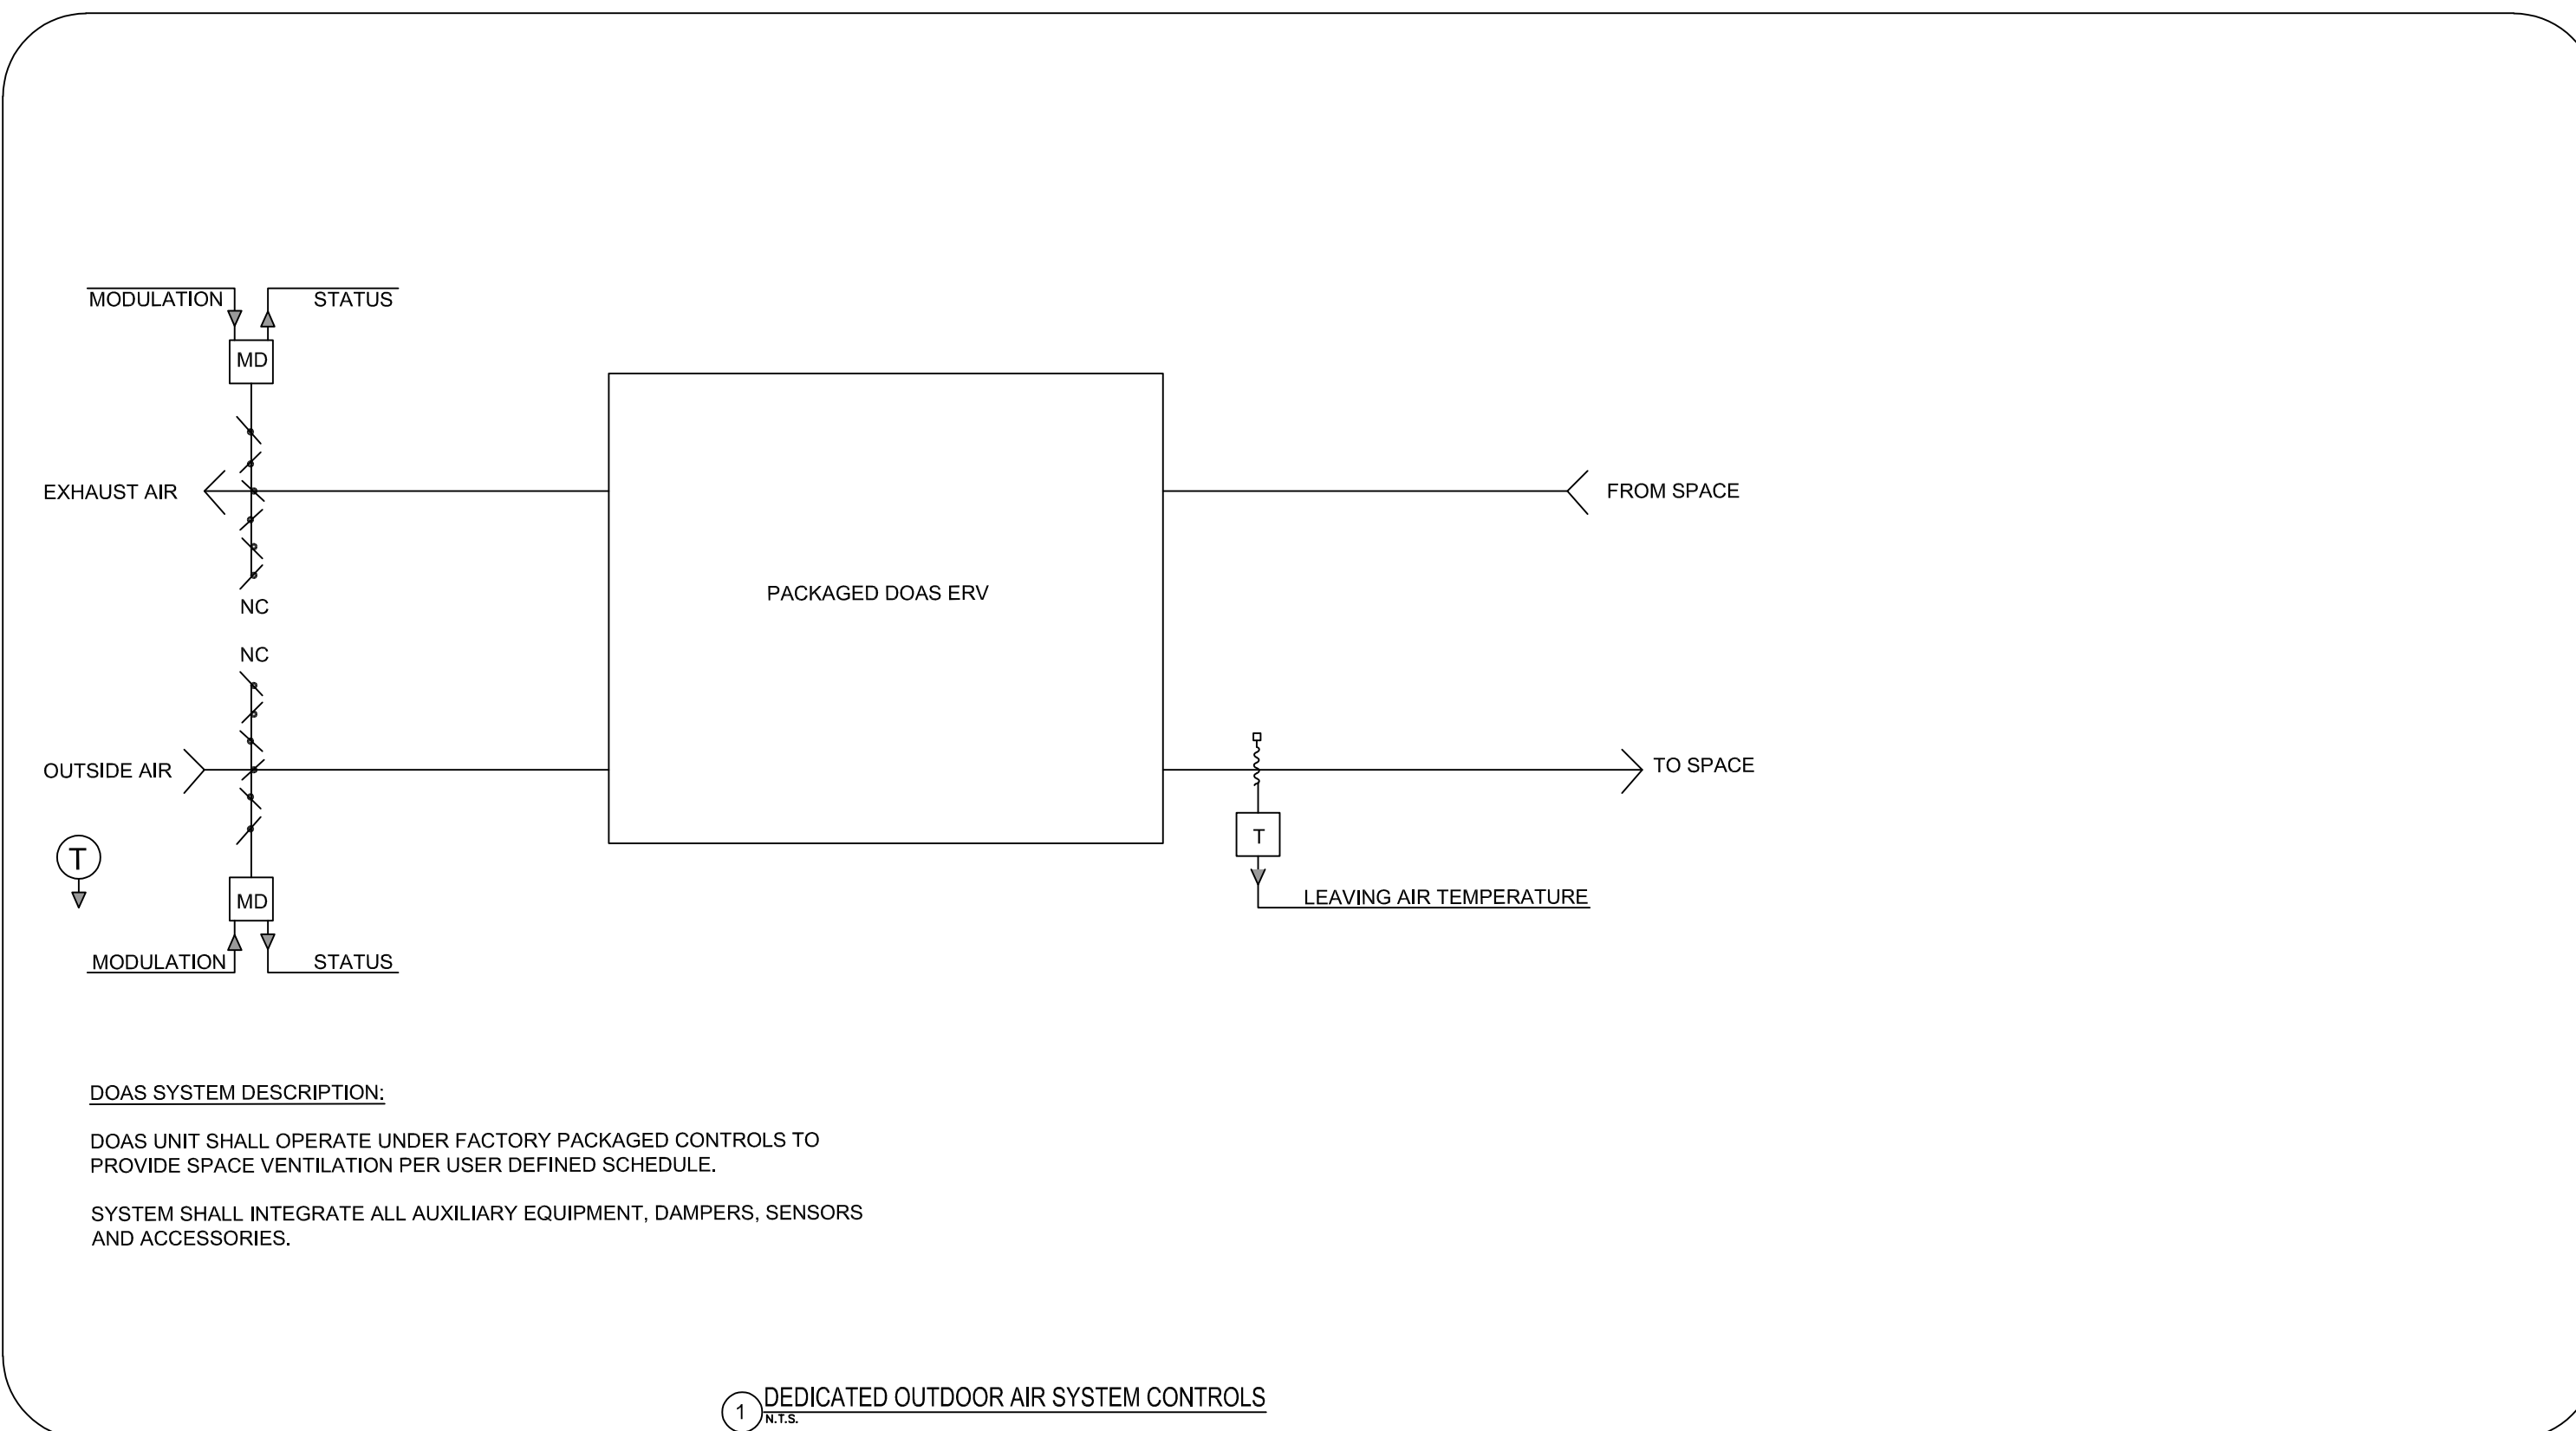

ABBREVIATIONS

ABV	ABOVE	FLR	FLOOR	OD	OUTSIDE DIMENSION	S/S	SERVICE SINK
AFF	ABOVE FINISHED FLOOR	FP	FIRE PROTECTION	OPG	OPENING	SPEC	SPECIFICATION
AP	ACCESS PANEL	FPM	FEET PER MINUTE	OS	OPEN SITE	SQ	SQUARE
-	-	FPS	FEET PER SECOND	OT	OFF TOP	SS	STAINLESS STEEL
BFP	BACK FLOW PREVENTOR	FS	FLOW SWITCH	OZ	OUNCE	SST	SUPPORT STEEL
BLDG	BUILDING	FT	FEET	-	-	STD	STANDARD
BLW	BELOW	FTB	FLOOR TO BOTTOM	PART	PARTIAL	STL	STEEL
BSMT	BASEMENT	FTC	FLOOR TO CENTERLINE	PDR	PLENUM DRAIN	STR	STRUCTURAL
-	-	FPH	FROST PROOF HYDRANT	PERF	PERFORATED	SUP	SUPPLY
CFH	CUBIC FEET PER HOUR	FXC	FLEXIBLE CONNECTION	P-	PLUMBING FIXTURE IDENTIFICATION	SYS	SYSTEM
CFM	CUBIC FEET PER MINUTE	-	-	PH	PHASE	SIP	STEAM IN PLACE
CHP	CONCRETE HOUSEKEEPING PAD	GA	GAUGE	PIV	POST INDICATOR VALVE	S/SHO	SAFETY SHOWER
CI	CAST IRON	GALV	GALVANIZED	POS	POSITIVE	-	-
CL	CENTER LINE	GC	GENERAL CONTRACTOR	PRESS	PRESSURE	TDH	TOTAL DYNAMIC HEAD
CLG	CEILING	GPD	GALLONS PER DAY	PS	PRESSURE SWITCH	TEMP	TEMPERATURE
CO	CLEAN OUT	GPH	GALLONS PER HOUR	PSI	POUNDS PER SQUARE INCH	TP	TOTAL PRESSURE
COL	COLUMN	GPM	GALLONS PER MINUTE	PSIG	POUNDS PER SQUARE INCH GAUGE	TT	TEMPERATURE TRANSMITTER
COMP	COMPRESSOR	-	-	-	-	TYP	TYPICAL
CONC	CONCRETE	HT	HEIGHT	PSIA	POUNDS PER SQUARE INCH ABSOLUTE	TI	TEMPERATURE INDICATOR
CONN	CONNECTION	HB	HOSE BIBB	PT	PRESSURE TRANSMITTER	-	-
CONTN	CONTINUATION	HD	HEAD (SEE SCHEDULES)	PV	PLUG VALVE	VI	VIBRATION ISOLATOR
CONTR	CONTRACTOR	HR	HOSE	PVC	POLYVINYL CHLORIDE	VTR	VENT THRU ROOF
CP	CONCRETE PIPE	HTR	HEATER	PVS	POLYVINYL COATED STEEL	-	-
CS	CUP SINK	-	-	PC	PLUMBING CONTRACTOR	W	WIDTH
*C	DEGREES CENTIGRADE	ID	INTERNAL DIAMETER	PI	PRESSURE INDICATOR	W/	WITH
-	-	INCL	INCLUDING	-	-	W/O	WITHOUT
DIA	DIAMETER	INV	INVERT	QUAN	QUANTITY	WC	WATER CLOSET
DIAG	DIAGRAM	-	-	QD	QUICK DISCONNECT	WCH	WATER CLOSET-HANDICAPPED
DISCH	DISCHARGE	K	TYPE OF COPPER TUBING	-	-	WM	WATER METER
-	-	-	-	-	-	-	-
DIW	DOWN IN WALL	LT	LEVEL TRANSMITTER	RA	RETURN AIR	-	-
DN	DOWN	LAV	LAVATORY	RAC	RUN ABOVE CEILING	-	-
DWG	DRAWING	MAX	MAXIMUM	RAF	RUN ABOVE FLOOR	-	-
-	-	MC	MECHANICAL CONTRACTOR	RATC	RUN AT CEILING	-	-
(E)	EXISTING	MR	MOP RECEPTOR	RBC	RUN BELOW CEILING	-	-
EA	EACH	MED	MEDIUM	RBF	RUN BELOW FLOOR	-	-
ELEV	ELEVATION	MFR	MANUFACTURER	RBG	RUN BELOW GRADE	-	-
ENT	ENTERING	MIN	MINIMUM	RBJ	RUN BETWEEN JOIST	-	-
EQ	EQUAL	MISC	MISCELLANEOUS	RCP	REINFORCED CONCRETE PIPE	-	-
EQUIP	EQUIPMENT	MTD	MOUNTED	RD	ROOF DRAIN	-	-
EQUIV	EQUIVALENT	M	TYPE OF COPPER TUBING	REL	RELIEF	-	-
ETC	AND SO FORTH	(N)	NEW	REQD	REQUIRED	-	-
EWC	ELECTRIC WATER COOLER	NC	NORMALLY CLOSED	RICW	RUN IN CASEWORK	-	-
EW	EYE WASH	NIC	NOT IN CONTRACT	RIE	RUN IN ENCLOSURE	-	-
EXT	EXTERNAL	NH	NO HUB	RIW	RISE IN WALL	-	-
-	-	No	NUMBER	RM	ROOM	-	-
*F	DEGREES FAHRENHEIT	NO	NORMALLY OPEN	ROD	ROOF OVERFLOW DRAIN	-	-
FA	FROM ABOVE	NPW	NON-POTABLE WATER	-	-	-	-
FB	FROM BELOW	NOM	NOMINAL	SA	SHOCK ABSORBER	-	-
FD	FLOOR DRAIN	NTS	NOT TO SCALE	SCH	SCHEDULE	-	-
FIN	FINISHED	-	-	SCHM	SCHEMATIC	-	-
FL	FLANGE	-	-	-	-	-	-
FLEX	FLEXIBLE	-	-	-	-	-	-


PIPING ELEMENTS/VALVING

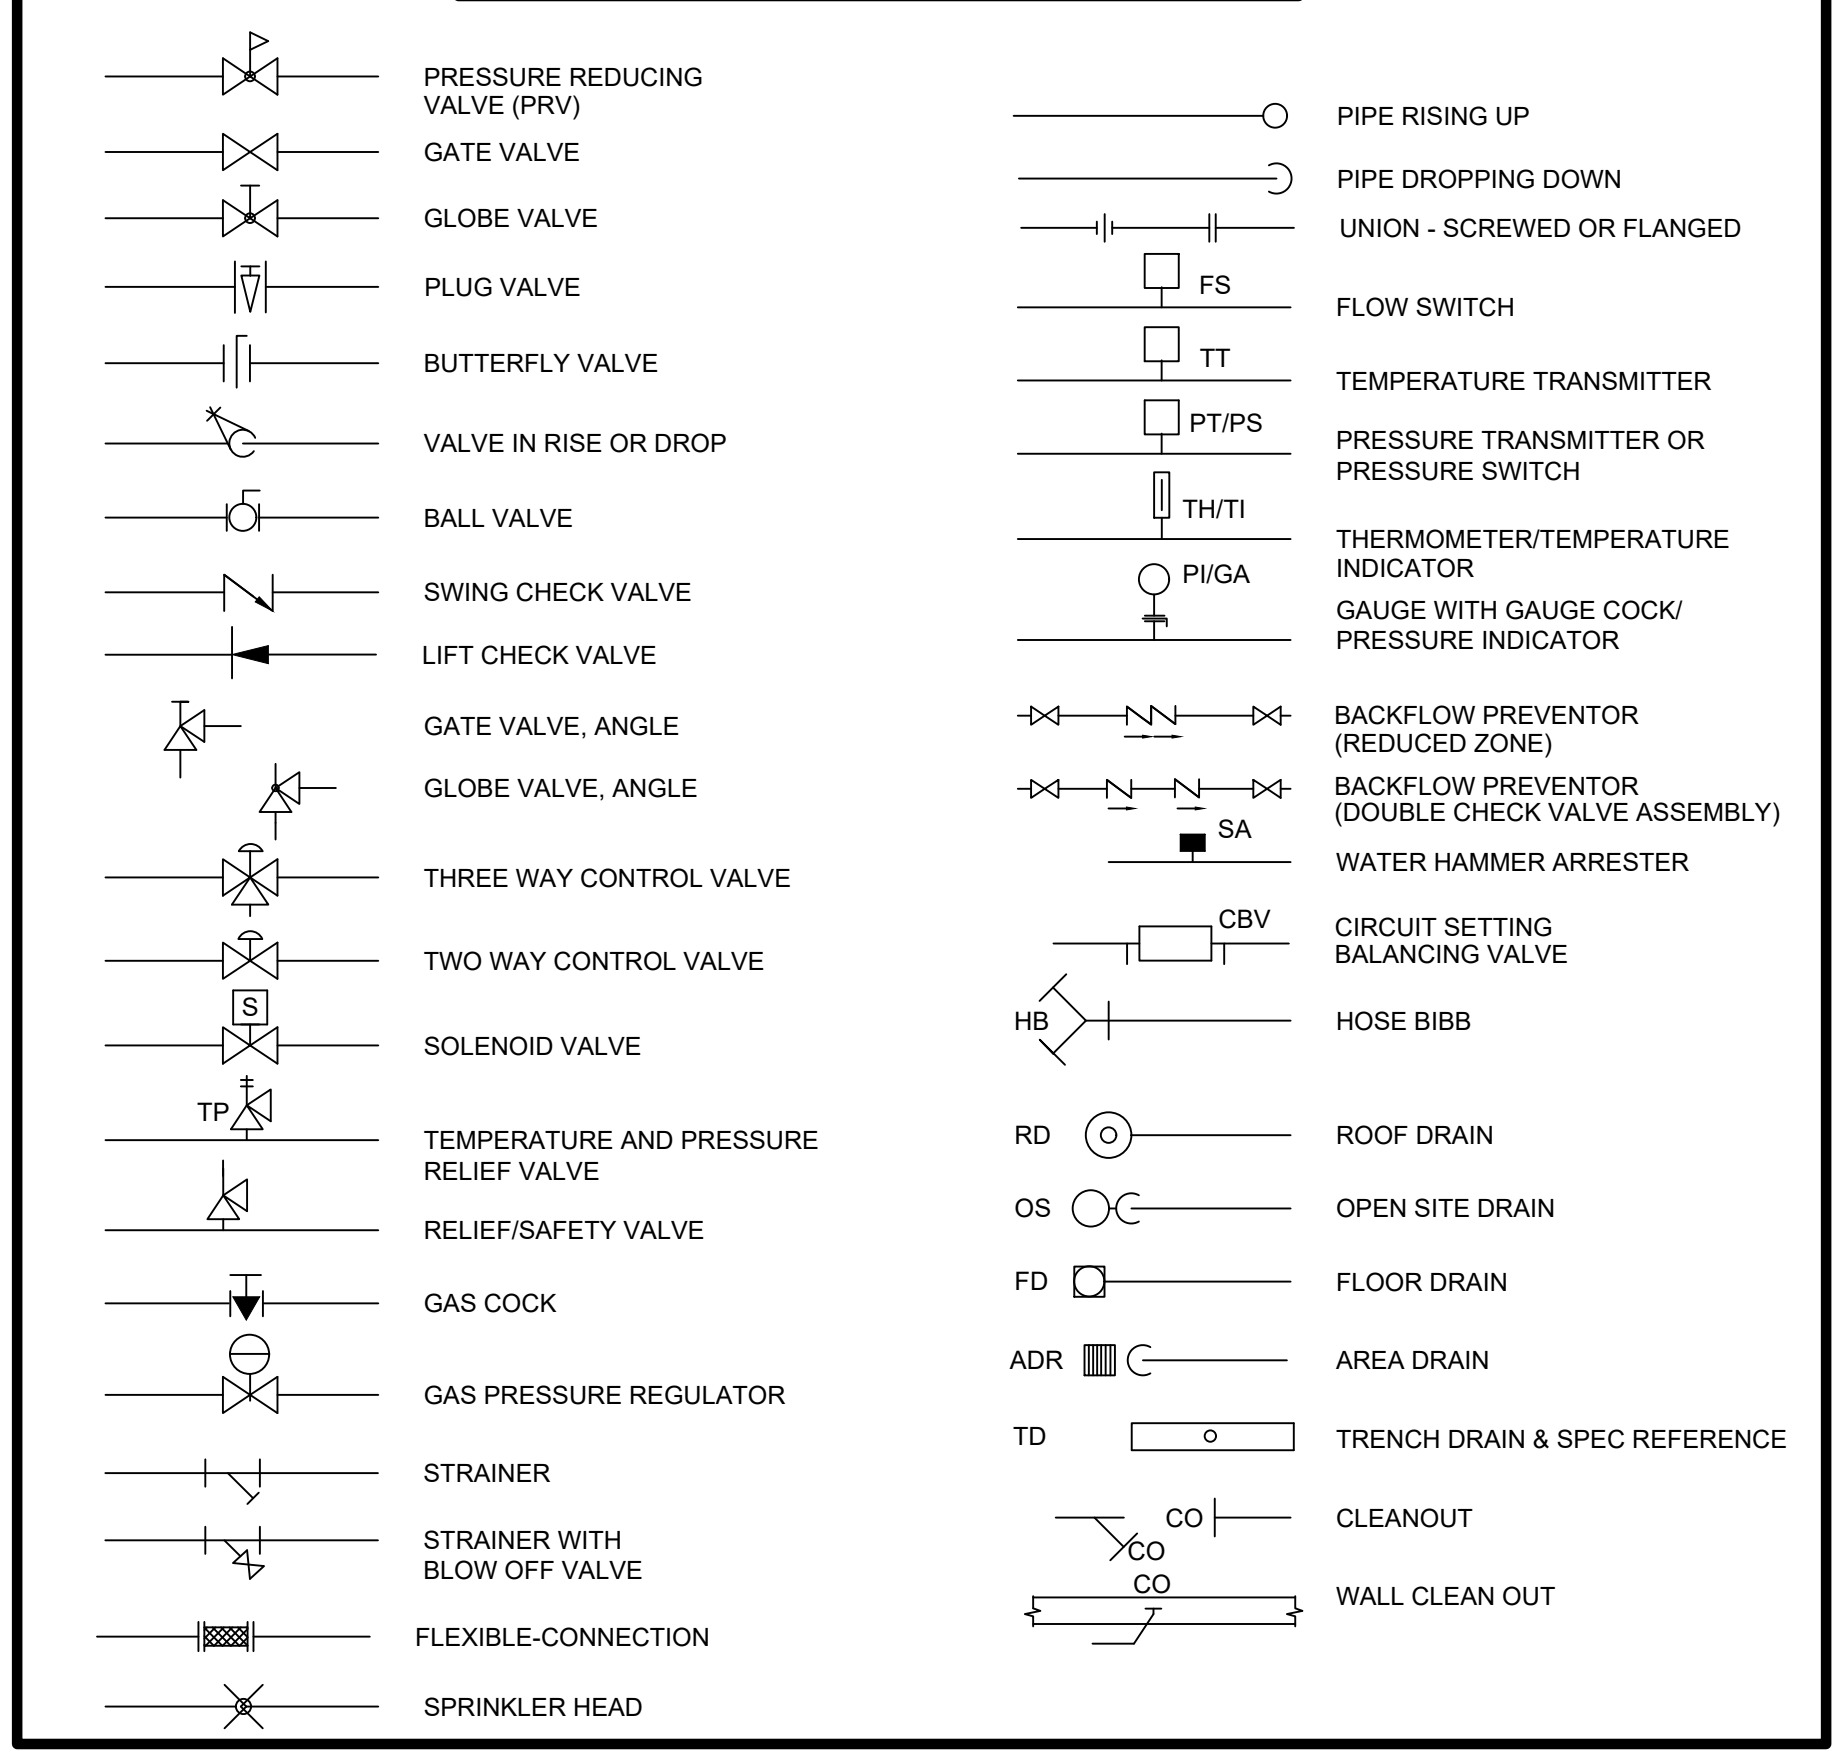


GENERAL SYMBOLS

E	EXISTING EQUIPMENT TO REMAIN
R	EXISTING EQUIPMENT TO BE REMOVED
ER	EXISTING EQUIPMENT TO BE RELOCATED
RE	RELOCATED EXISTING EQUIPMENT

REFERENCE SYMBOLS

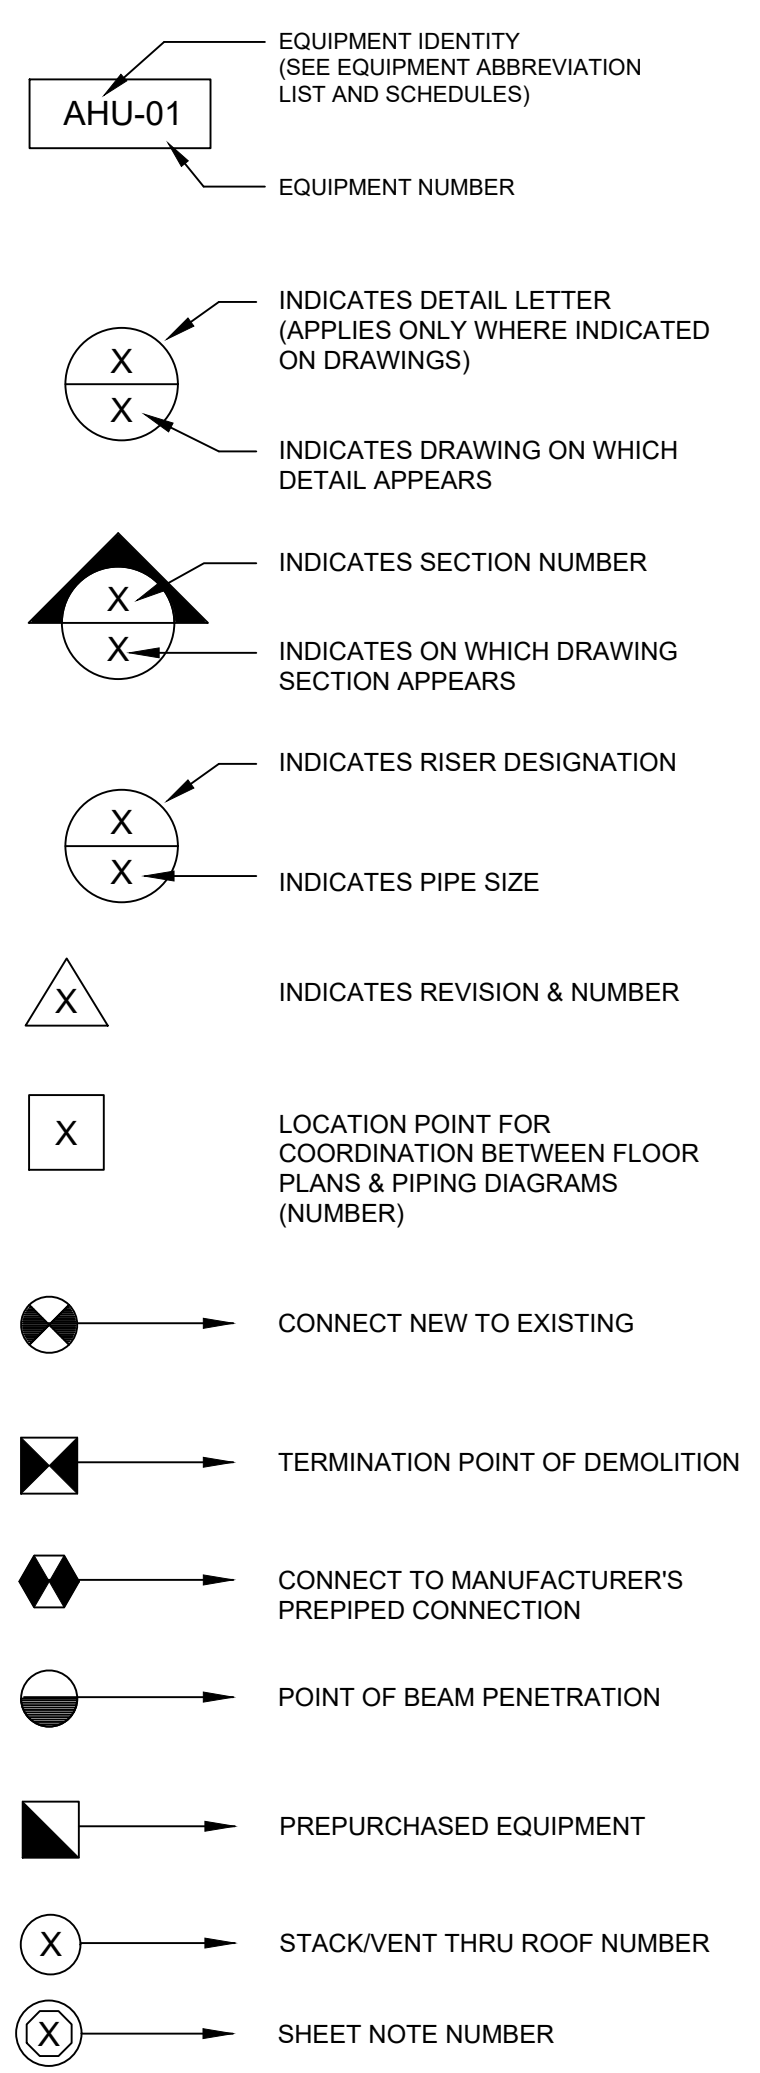

PIPING SYMBOLS

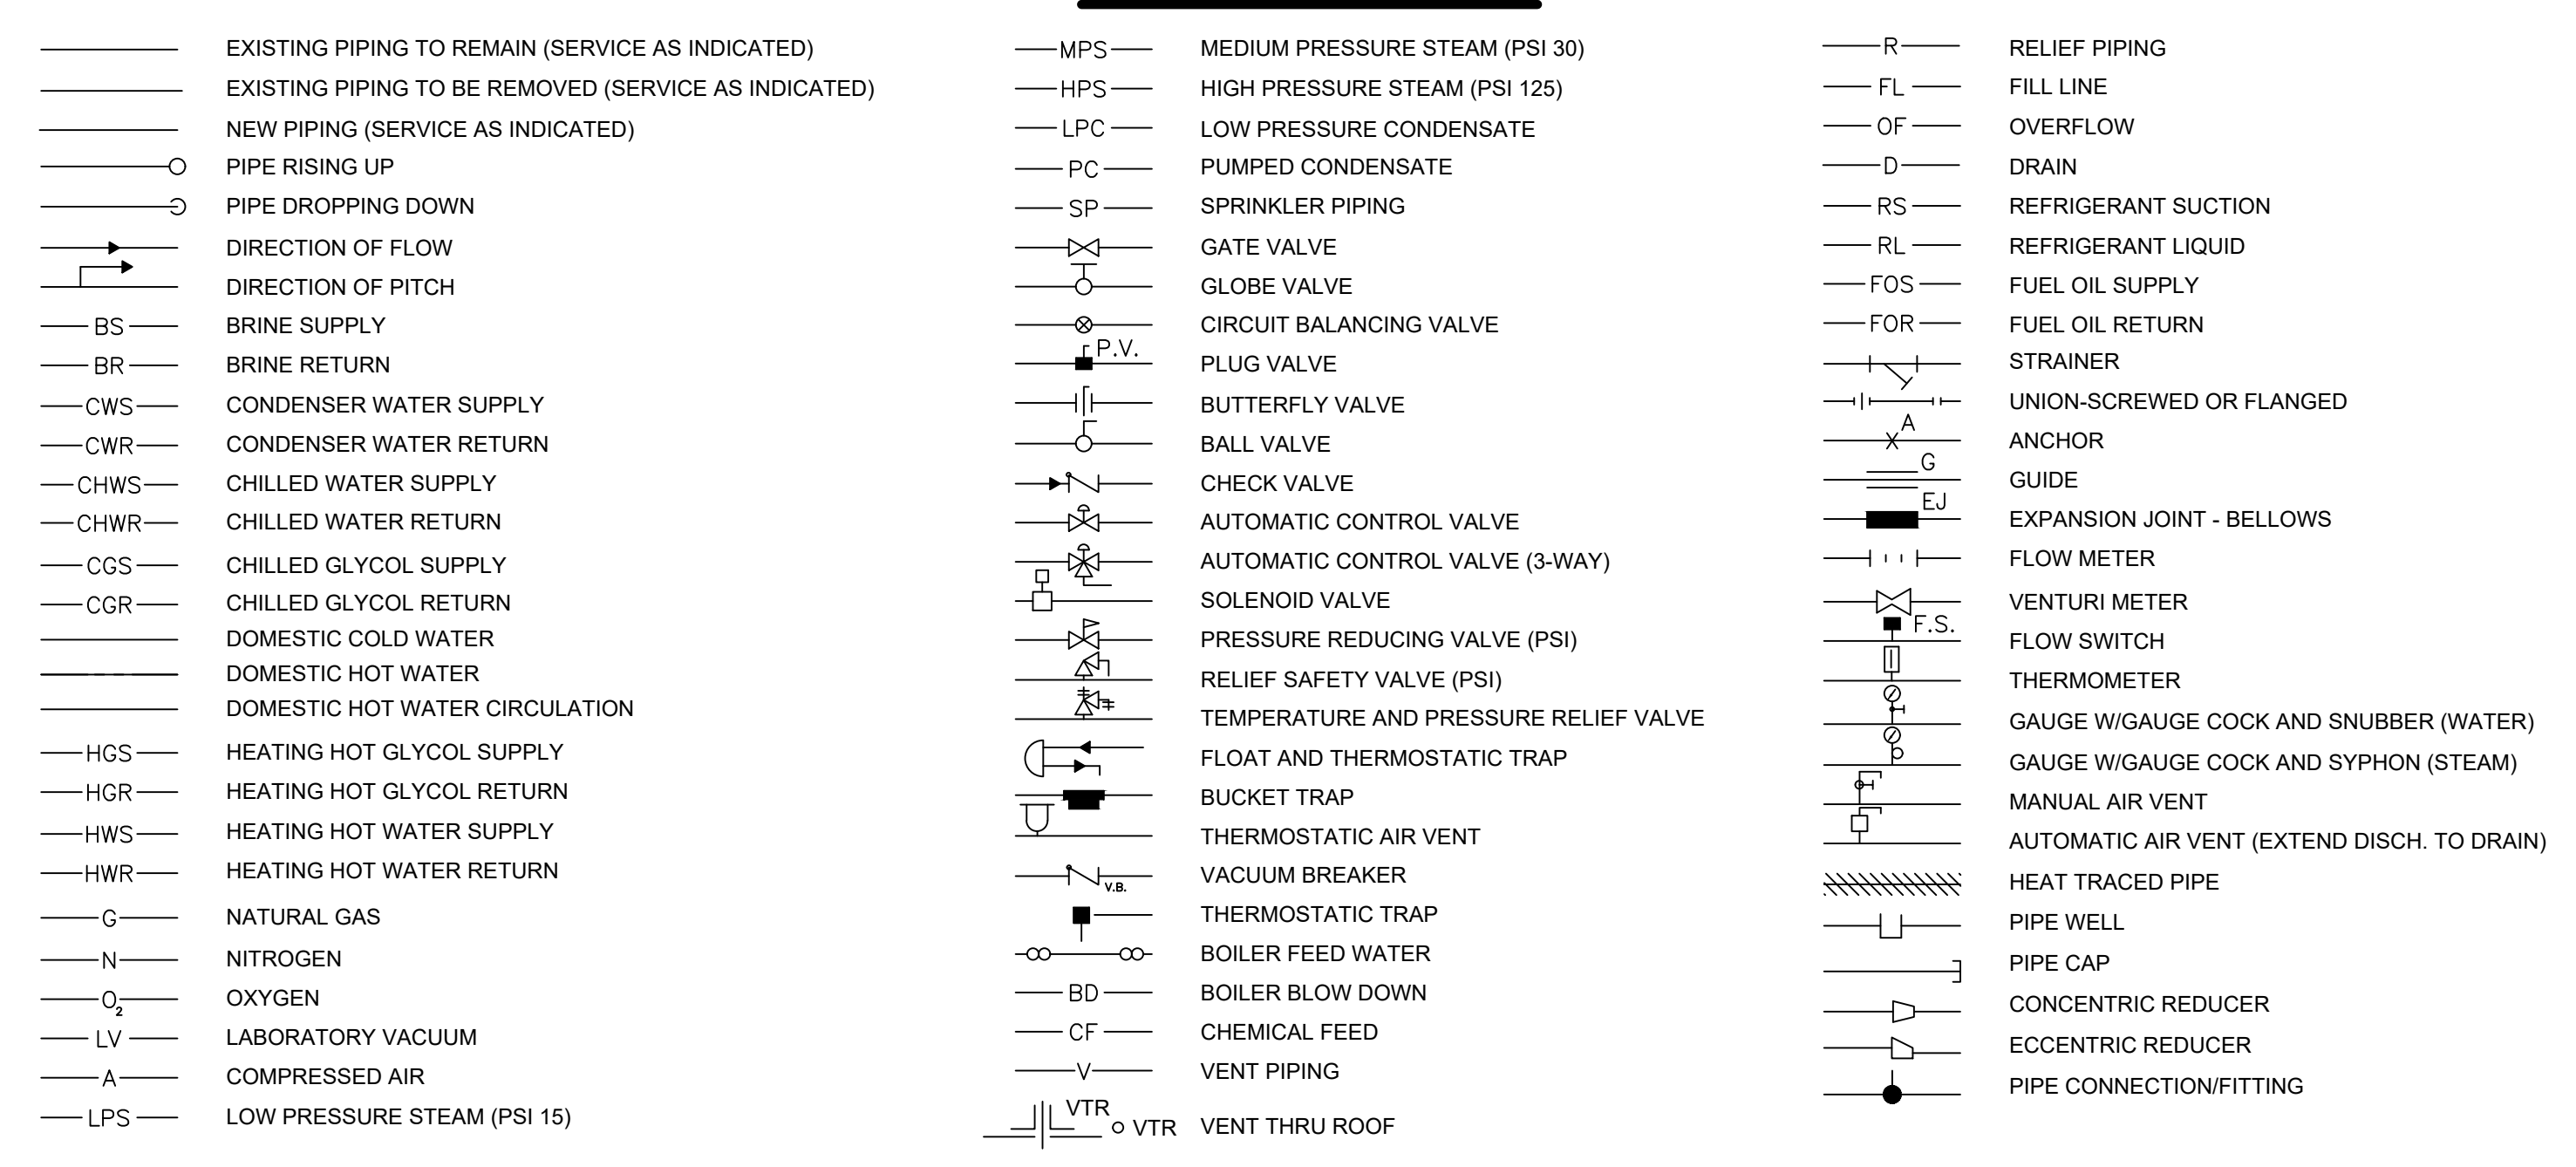

DRAWING INDEX

P0.0	LEGENDS AND ABBREVIATIONS
P0.1	SPECIFICATIONS
P0.2	EQUIPMENT SCHEDULES
P1.0	UNDERGROUND PLUMBING DEMOLITION PLAN
P1.1	FIRST FLOOR PLUMBING DEMOLITION PLAN
P1.2	UNDERGROUND PLUMBING PLAN
P1.3	FIRST FLOOR PLUMBING PLAN
P3.0	DETAILS

NOTE:
ALL ABBREVIATIONS AND SYMBOLS MAY NOT APPEAR ON THE DRAWINGS FOR THIS PROJECT.



**SKAGIT COUNTY
CONCRETE COMMUNITY
CENTER**

NO.	REVISIONS

stage:	BID SET
client:	CARLETTI ARCHITECTS
project:	CONCRETE COMMUNITY CENTER 45821 RAILROAD AVE CONCRETE, WASHINGTON
drawn by:	NH
original sheet size:	24x36
revision:	None
date:	2025.02.18
scale:	

LEGENDS AND ABBREVIATIONS

sheet.
P0.0

PLUMBING FIXTURE SCHEDULE										
TAG	FIXTURE TYPE	BASIS OF DESIGN		CONNECTION SIZE				DESCRIPTION	NOTES	
		MAKE	MODEL	WASTE	VENT	HOT WATER	COLD WATER			
WC-1	TOILET	AMERICA STANDARD	CADET	4"	2"	-	1-1/2"	BEMIS SEAT OPEN FRONT		
UR-1	URINAL	AMERICA STANDARD	PINTBROOK	2"	1-1/2"	-	1-1/4"	W/AMERICA STANDARD SELECTION FLUSH VALVE, HARDWIRED		
LAV-1	LAVATORY	AMERICA STANDARD	DECORUM 21x20.25	1-1/2"	1-1/2"	1/2"	1/2"	WIKOHLER K-9728-4 MANUAL FAUCET		
DF-1	DRINKING FOUNTAIN	ELKAY	LZWS-LRP9M28K	2"	1-1/2"	-	3/4"	BI LEVEL REFRIGERATED DRINKING FOUNTAIN WITH BOTTLE FILLING STATION, 115V, 10 AMPS		
SH-1	SHOWER	FREEDOM SHOWERS	APF3838 BF RRF	2"	1-1/2"	1/2"	1/2"	FREEDOM ADA TRANSFER SHOWER, RIGHT VALVE WALL		
MS-1	MOP SINK	FIAT	TSBC1610 24x24	3"	1-1/2"	1/2"	1/2"	WISERVICE FAUCET WITH 3/4" HOSE THREAD SPOUT, PAL HOOK, HOSE AND HOSE BRACKET, MOP HANGER		
FD-1	FLOOR DRAIN	SILOUX CHIEF	-	2"	1-1/2"	-	-	PVC BODY WITH FLASHING COLLAR AND ADJUSTABLE STRAINER HEAD		
HB-1	FROST PROOF HOSE BIB	WOODFORD	MODEL 65	-	-	-	3/4"	-		
WB-1	WASHER BOX	GLY GRAY	MWB	2"	1-1/2"	1/2"	1/2"	REVERSIBLE DRAIN, WHITE POWDER COATED, QUARTER TURN VALVES		
WCO	WALL CLEANOUT	JR SMITH	-	-	-	-	-	PER PLANS		
FCO	FLOOR CLEANOUT	JR SMITH	-	-	-	-	-	PER PLANS		
COTG	CLEANOUT AT GRADE	JR SMITH	-	-	-	-	-	PER PLANS		

NOTES:
1. INSTALL ADA FIXTURES PER LATEST ADA STANDARDS. INSTALL FLUSH VALVES WITH HANDLES TOWARD THE WIDE SIDE OF THE STALL.
2. PROVIDE SINKS AND LAVATORIES WITH INSULATED TRAPS, STOPS AND SUPPLIES.
3. PROVIDE CHROME PLATES COMMERCIAL GRADE STOPS AND SUPPLIES.
4. VERIFY EXACT LOCATION OF DRAINS WITH ARCHITECT/GENERAL CONTRACTOR PRIOR TO INSTALLATION.
5. PROVIDE FLOOR DRAINS/SINKS/MOP SINKS WITH TRAP PRIMER PORT. PROVIDE TRAP PRIMER VALVE WITH DISTRIBUTION UNIT. CONNECT UP TO FOUR DRAINS TO ONE TRAP PRIMER. CAP ANY UNUSED CONNECTIONS. PROVIDE BALL VALVE AND TOP PIPE CONNECTION FOR EACH VALVE.

TABLE C403.3.1 PIPING VOLUME AND MAXIMUM PIPING LENGTHS			
NOMINAL PIPE SIZE (inches)	VOLUME (liquid ounces per foot length)	MAXIMUM PIPING LENGTH (feet)	
		Public lavatory faucets	Other fixtures and appliances
1/4	0.33	6	50
5/16	0.5	4	50
3/8	0.75	3	50
1/2	1.5	2	43
5/8	2	1	32
3/4	3	0.55	21
7/8	4	0.55	16
1	5	0.55	13
1-1/4	8	0.55	8
1-1/2	11	0.55	6
2 or larger	18	0.55	4

TABLE C403.10.3 MINIMUM PIPE INSULATION THICKNESS (thickness is in inches) ^a							
FLUID OPERATING TEMPERATURE RANGE AND USAGE (°F)	INSULATION CONDUCTIVITY		NOMINAL PIPE OR TUBE SIZE (inches)				
	Conductivity Btu · in./h · ft ² · °F ^b	Mean Rating Temperature, °F	<1	1 to < 1-1/2	1-1/2 to < 4	4 to < 8	≥ 8
> 350	0.32 – 0.34	250	4.5	5.0	5.0	5.0	5.0
251 - 350	0.29 – 0.32	200	3.0	4.0	4.5	4.5	4.5
201 - 250	0.27 – 0.30	150	2.5	2.5	2.5	3.0	3.0
141 - 200	0.25 – 0.29	125	1.5	1.5	2.0	2.0	2.0
105 - 140	0.21 – 0.28	100	1.0	1.0	1.5	1.5	1.5
40 - 60	0.21 – 0.27	75	0.5	0.5	1.0	1.0	1.0
<40	0.20 – 0.26	75	0.5	1.0	1.0	1.0	1.5

a. For piping smaller than 1-1/2 inch (38 mm) and located in partitions within conditioned spaces, reduction of these thicknesses by 1 inch (25 mm) shall be permitted (before thickness adjustment required in footnote b) but not to a thickness less than 1 inch (25 mm).

b. For insulation outside the stated conductivity range, the minimum thickness (T) shall be determined as follows:
 $T = r((1 + tr)/Kk - 1)$
where:
T = minimum insulation thickness,
r = actual outside radius of pipe,
t = insulation thickness listed in the table for applicable fluid temperature and pipe size,
K = conductivity of alternate material at mean rating temperature indicated for the applicable fluid temperature (Btu · in/h · ft² · °F) and
k = the upper value of the conductivity range listed in the table for the applicable fluid temperature.

c. For direct-buried heating and hot water system piping, reduction of these thicknesses by 1 1/2 inches (38 mm) shall be permitted (before thickness adjustment required in footnote b) but not to thicknesses less than 1 inch (25 mm).

WATER HEATER SCHEDULE														
TAG	SHEET LOCATION	BASIS OF DESIGN		TYPE	EWT F	LWT F	ELECTRICAL				CONNECTION SIZE IN	TANK CAPACITY GAL	WEIGHT (lbs)	ACCESSORIES
		MAKE	MODEL				KW	ELEMENTS	VOLTAGE	PHASE				
WH-1	P1.3	RHEEM	ELD-120	ELEC	40	140	6.05 (EA)	2	240	1	3/4	119	1385	

CIRCULATION PUMP SCHEDULE													
TAG	SHEET LOCATION	BASIS OF DESIGN		FLOW GPM	FT HD	ELECTRICAL				CONNECTION SIZE IN	WEIGHT (lbs)	ACCESSORIES	
		MAKE	MODEL			WATTS	RPM	VOLTAGE	PHASE				CONTROL
CP-1	P1.3	BELL AND GOSSETT	ECCOCR 20-18	20	10	70	-	115	1	-	1	10	


EXPANSION TANK SCHEDULE										
TAG	SHEET LOCATION	BASIS OF DESIGN		CAPACITY GAL	ACCEPTANCE FACTOR	TANK DIA IN	RATING PSI	CONNECTION SIZE IN	WEIGHT (lbs)	ACCESSORIES
		MAKE	MODEL							
ET-1		AMTROL	THERM-X-TROL ST-20VC-DD	8.6	0.37	12	150	3/4	110	

NOTES:
1. PROVIDE WITH ASME RATING.

CLEANOUTS UPC TABLE 707.1		
SIZE OF PIPE (INCHES)	SIZE OF CLEANOUT (INCHES)	THREADS (PER INCHES)
1-1/2	1-1/2	11-1/2
2	1-1/2	11-1/2
2-1/2	2-1/2	8
3	2-1/2	8
4 & LARGER	3-1/2	8



JTK ENGINEERING
HVAC | PLUMBING | ENERGY
WWW.JTKENG.COM

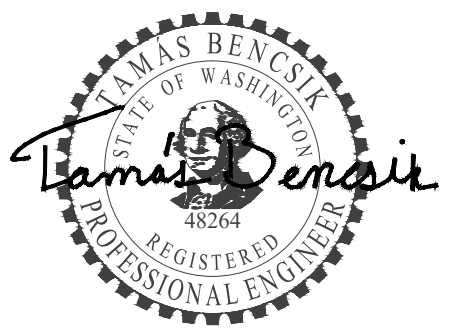

February 15, 2025



CARLETTI ARCHITECTS P.S.
116 EAST FR STREET
SUITE A
MOUNT VERNON, WA 98273
Phone: (360) 434-0384
Fax: (360) 424-3726



**SKAGIT COUNTY
CONCRETE COMMUNITY
CENTER**

REVISIONS

stage: **BID SET**

client: **CARLETTI ARCHITECTS**

project: **CONCRETE COMMUNITY CENTER
45821 RAILROAD AVE
CONCRETE,
WASHINGTON**

drawn by: **NH**

original sheet size: **24x36**

revision: **None**

date: **2025.02.18**

scale:


SCHEDULES

sheet.

P0.2



JTK ENGINEERING
HVAC | PLUMBING | ENERGY
WWW.JTKENG.COM

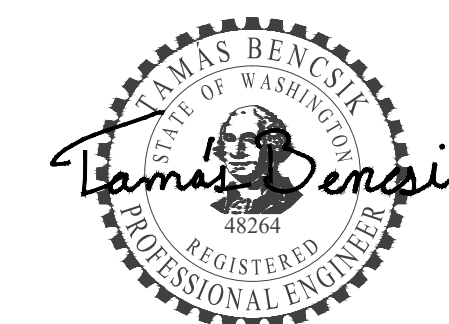

February 15, 2025



CARLETTI ARCHITECTS P.S.
ARCHITECTS, ENGINEERS, INTERIORS
116 EAST FR STREET
SUITE A
MOUNT VERNON, WA 98273
Phone: (360) 434-0384
Fax: (360) 424-3726



SKAGIT COUNTY CONCRETE COMMUNITY CENTER

REVISIONS

NO.	DATE	DESCRIPTION

stage: **BID SET**

client: **CARLETTI ARCHITECTS**

project: **CONCRETE COMMUNITY CENTER
45821 RAILROAD AVE
CONCRETE,
WASHINGTON**

drawn by: **NH**

original sheet size: **24x36**

revision: **None**


date: **2025.02.18**

scale:

UNDERGROUND PLUMBING DEMOLITION PLAN

sheet:

P1.0

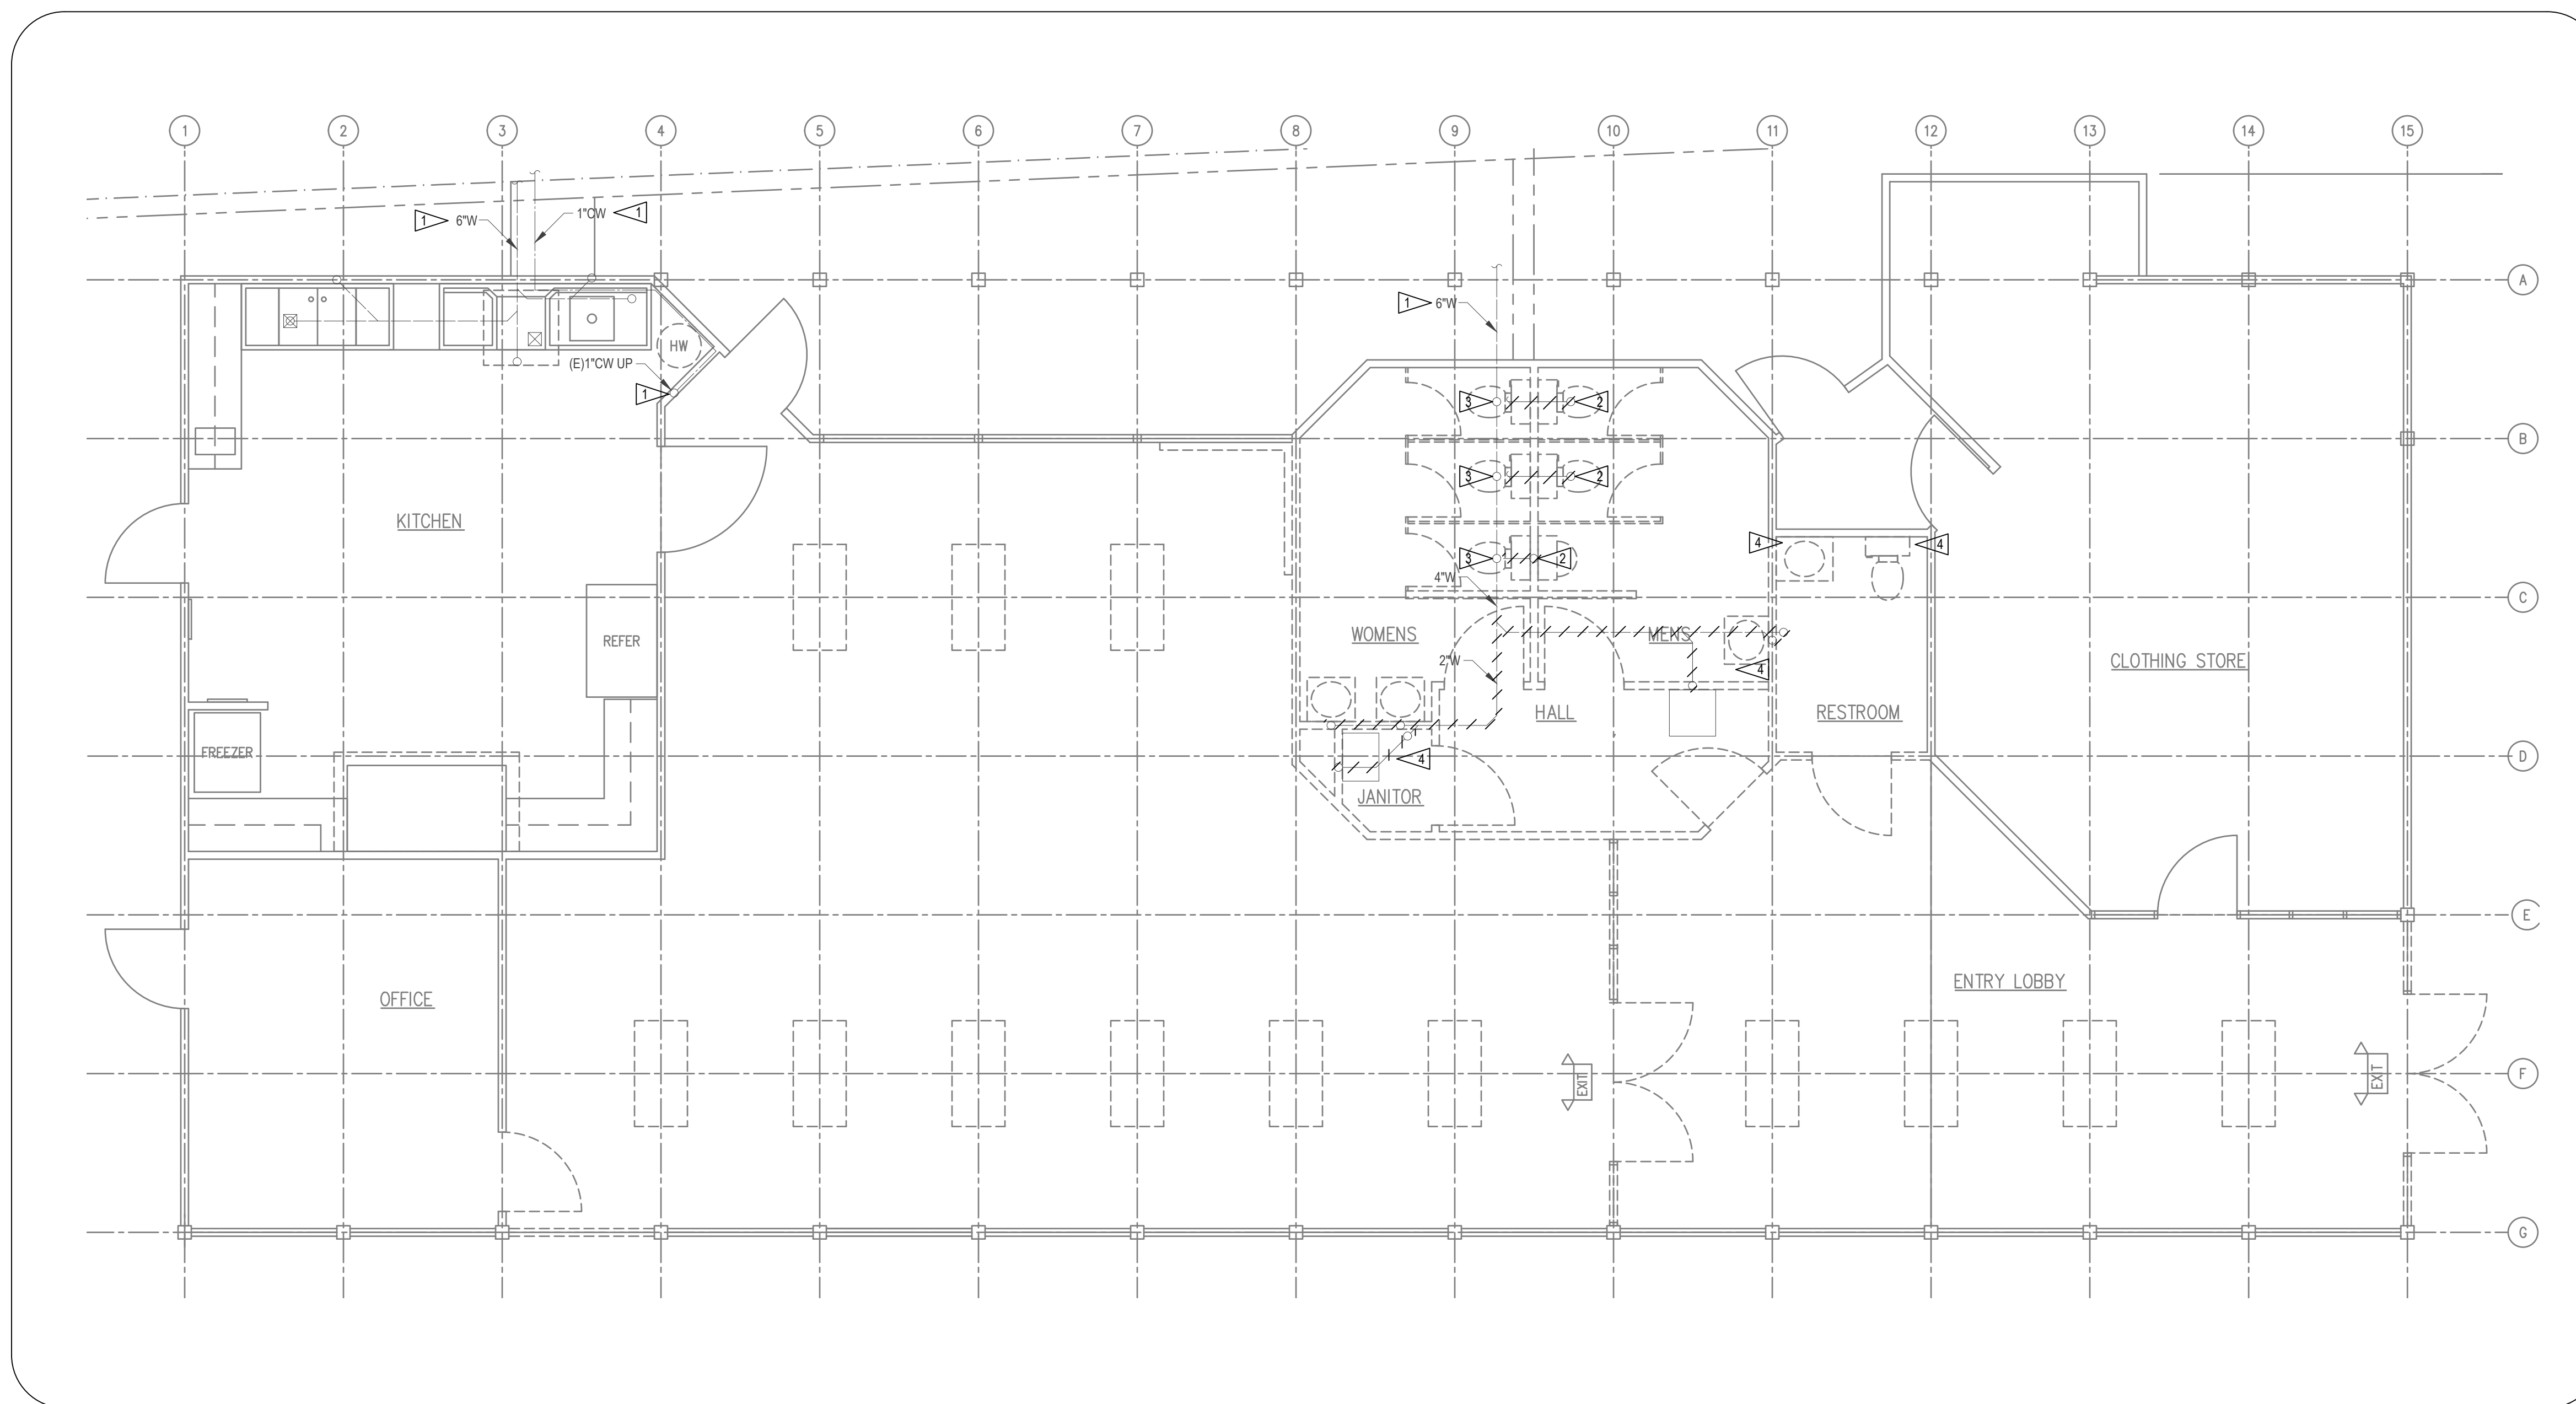


- KEYED NOTES:**
- 1 EXISTING TO REMAIN.
 - 2 DEMOLISH EXISTING WASTE PIPING AND CAP AT MAIN.
 - 3 CAP EXISTING WASTE PIPING.
 - 4 SELECTIVELY DEMOLISH EXISTING WASTE PIPING.

1 UNDERGROUND PLUMBING DEMOLITION PLAN
P1.0 SCALE: 1/4" = 1'-0"



JTK ENGINEERING
HVAC | PLUMBING | ENERGY
WWW.JTKENG.COM

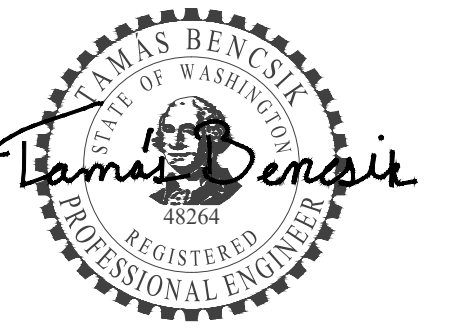

February 15, 2025



CARLETTI ARCHITECTS P.S.
ARCHITECTS, ENGINEERS, INTERIORS
116 EAST FIR STREET
SUITE A
MOUNT VERNON, WA 98273
Phone: (360) 434-0384
Fax: (360) 424-3726



**SKAGIT COUNTY
CONCRETE COMMUNITY
CENTER**

REVISIONS

stage: **BID SET**

client: **CARLETTI ARCHITECTS**

project: **CONCRETE COMMUNITY CENTER
45821 RAILROAD AVE
CONCRETE,
WASHINGTON**

drawn by: **NH**

original sheet size: **24x36**

revision: **None**


date: **2025.02.18**

scale:

**FIRST FLOOR
PLUMBING
DEMOLITION PLAN**

sheet:

P1.1

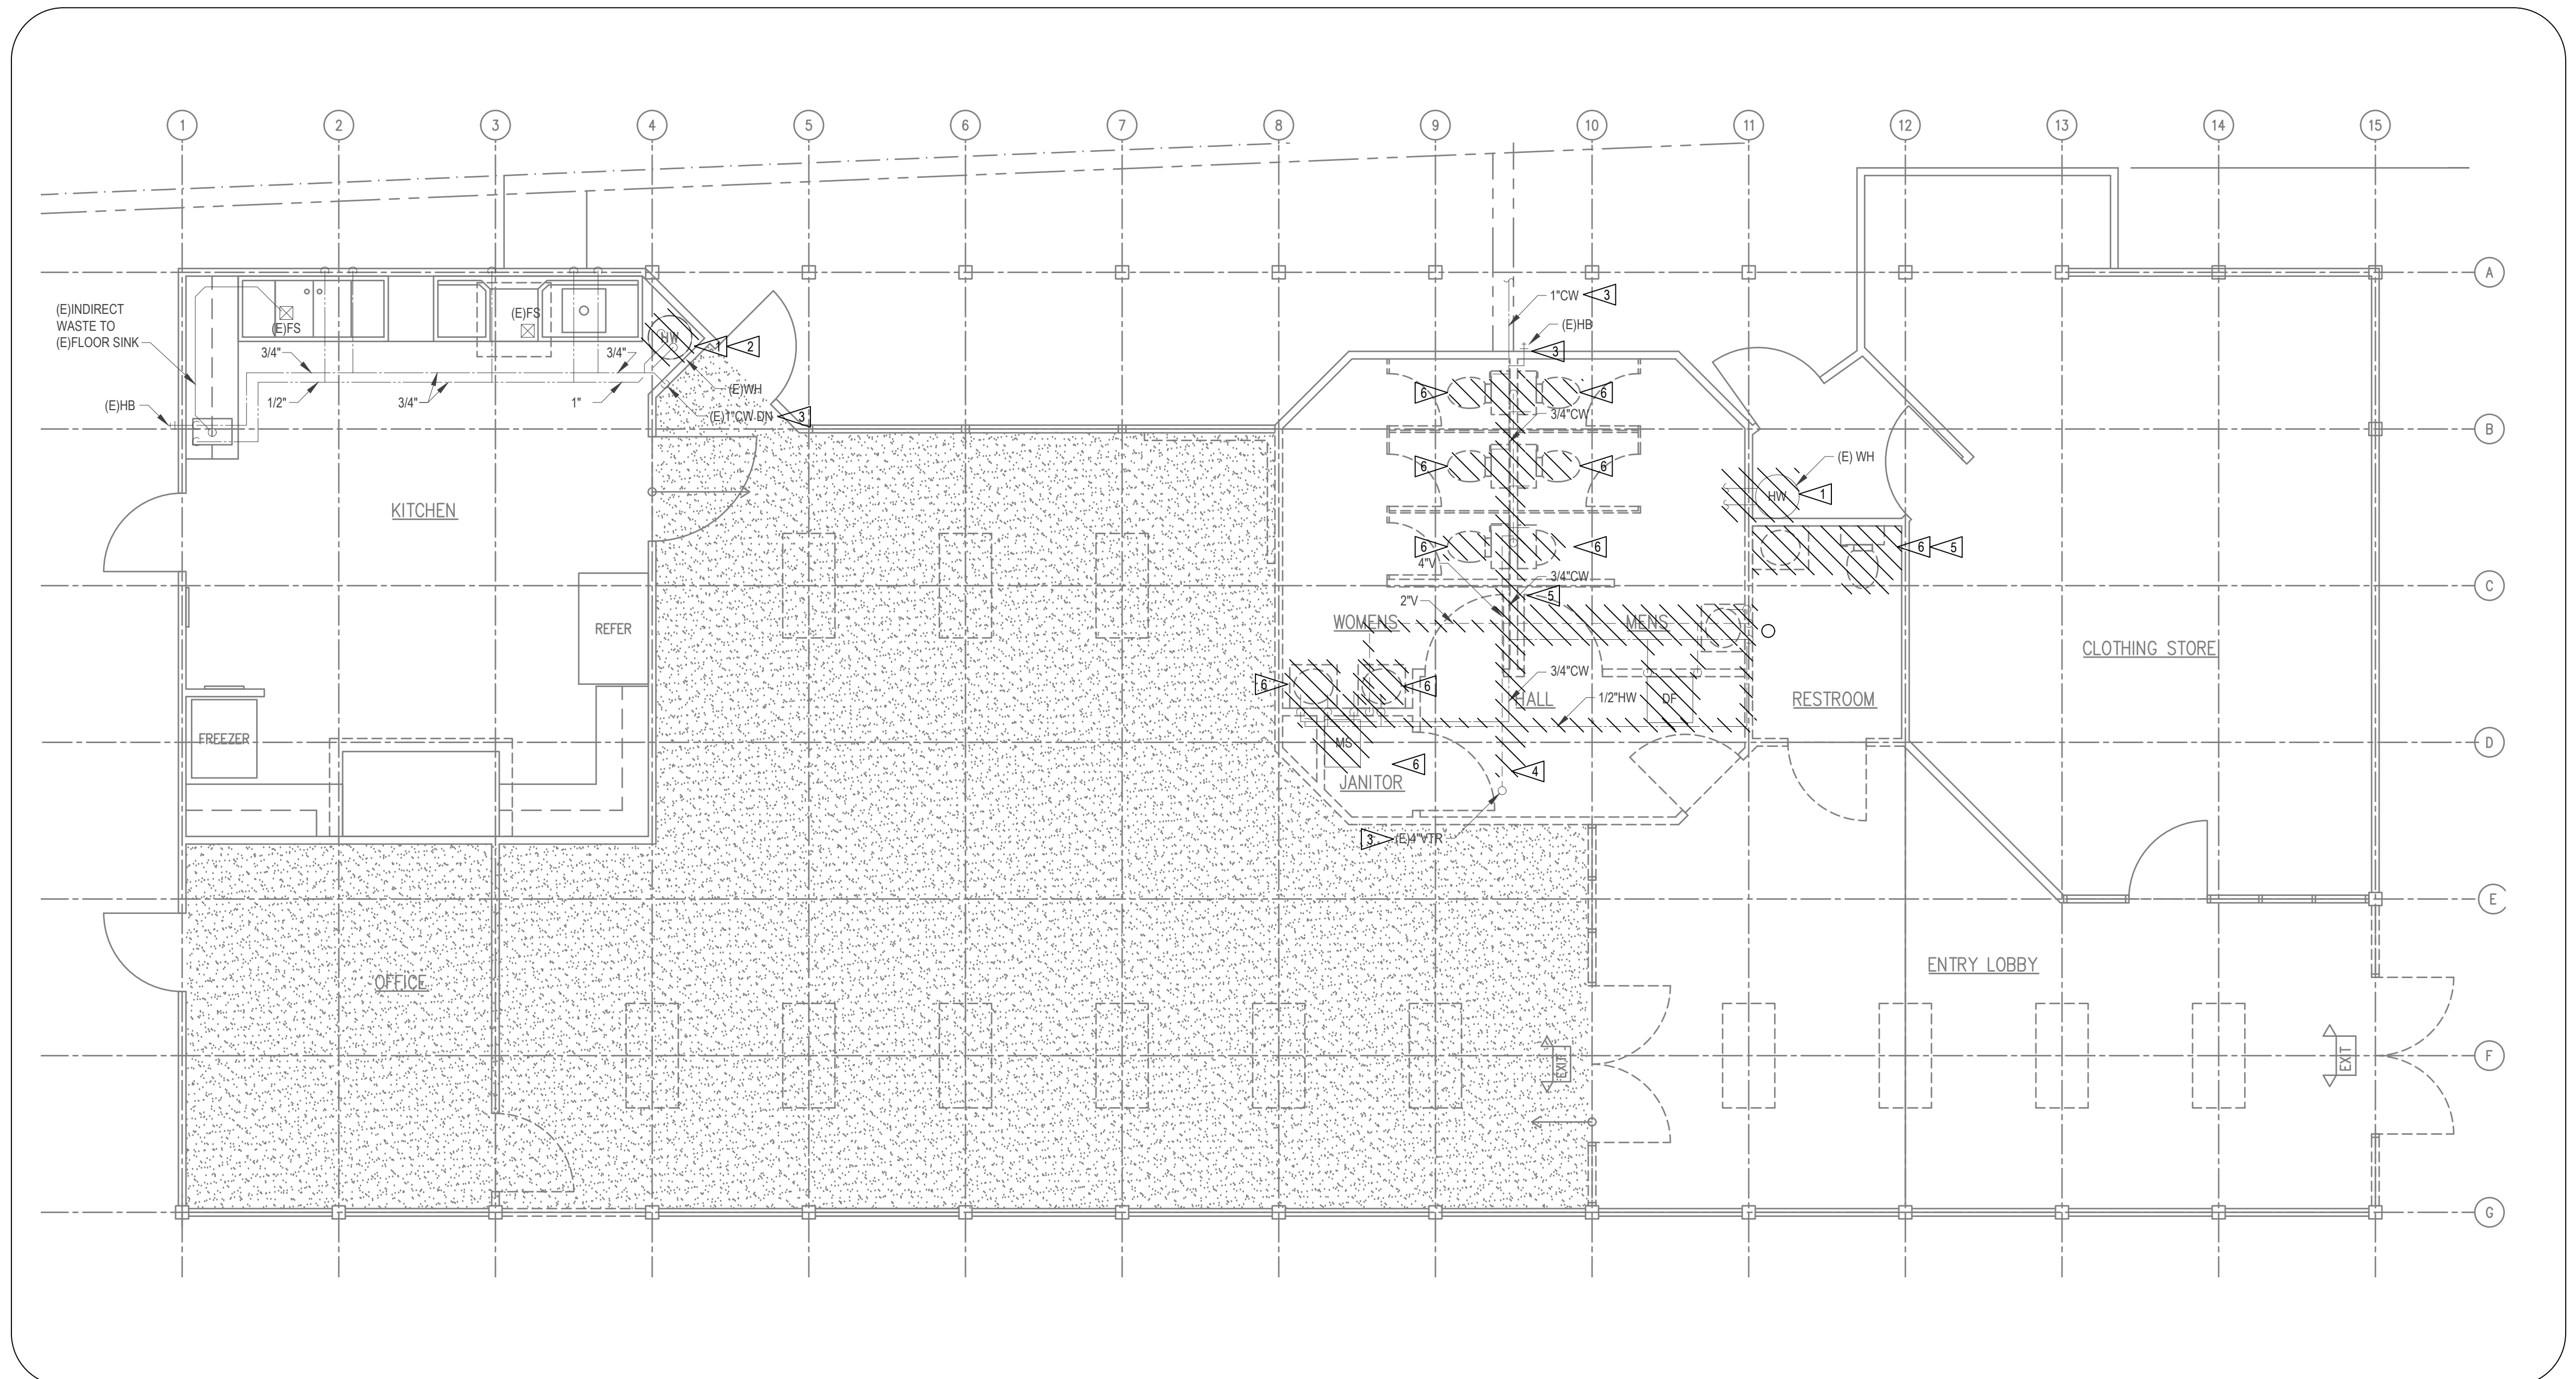


- KEYED NOTES:**
- 1** DEMOLISH EXISTING WATER HEATER.
 - 2** SELECTIVELY DEMOLISH EXISTING PIPING TO ACCOMMODATE DEMOLITION OF WATER HEATER AND INSTALLATION OF NEW WATER HEATER IN NEW LOCATION.
 - 3** EXISTING TO REMAIN.
 - 4** DEMOLISH EXISTING WASTE/VENT PIPING.
 - 5** SELECTIVELY DEMOLISH EXISTING HOT WATER AND COLD WASTER PIPING.
 - 6** DEMOLISH EXISTING PLUMBING FIXTURE AND ACCESSORIES.

1 FIRST FLOOR PLUMBING DEMOLITION PLAN
P1.1 SCALE: 1/4" = 1'-0"



JTK ENGINEERING
HVAC | PLUMBING | ENERGY
WWW.JTKENG.COM

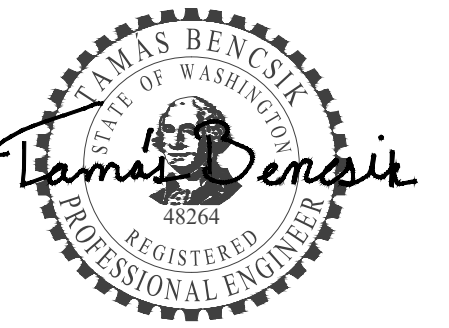

February 15, 2025



CARLETTI ARCHITECTS P.S.
ARCHITECTS, PLANNING, INTERIOR DESIGN
116 EAST FR. STREET
SUITE A
MOUNT VERNON, WA 98273
Phone: (360) 434-6384
Fax: (360) 424-3726



**SKAGIT COUNTY
CONCRETE COMMUNITY
CENTER**

REVISIONS

NO.	DATE	DESCRIPTION

stage: **BID SET**

client: **CARLETTI ARCHITECTS**

project: **CONCRETE COMMUNITY CENTER
45821 RAILROAD AVE
CONCRETE,
WASHINGTON**

drawn by: **NH**

original sheet size: **24x36**

revision: **None**

date: **2025.02.18**

scale:

**UNDERGROUND
PLUMBING
PLAN**

sheet:


P1.2

GENERAL NOTES:


- BUILDING IS SLAB ON GRADE. ROUTE HORIZONTAL PIPING BELOW THE CAPILLARY BREAK LAYER. REFER TO STRUCTURAL AND ARCHITECTURAL DRAWINGS FOR FLOOR ASSEMBLY THICKNESS.
- REFER TO PLUMBING FIXTURE SCHEDULE FOR FIXTURE BRANCH PIPE SIZES.
- PROVIDE TRAP PRIMER FOR EACH FLOOR DRAIN, SINK AND HUB DRAIN.


KEYED NOTES:

- 1 PROVIDE CONNECTION TO EXISTING PIPING.

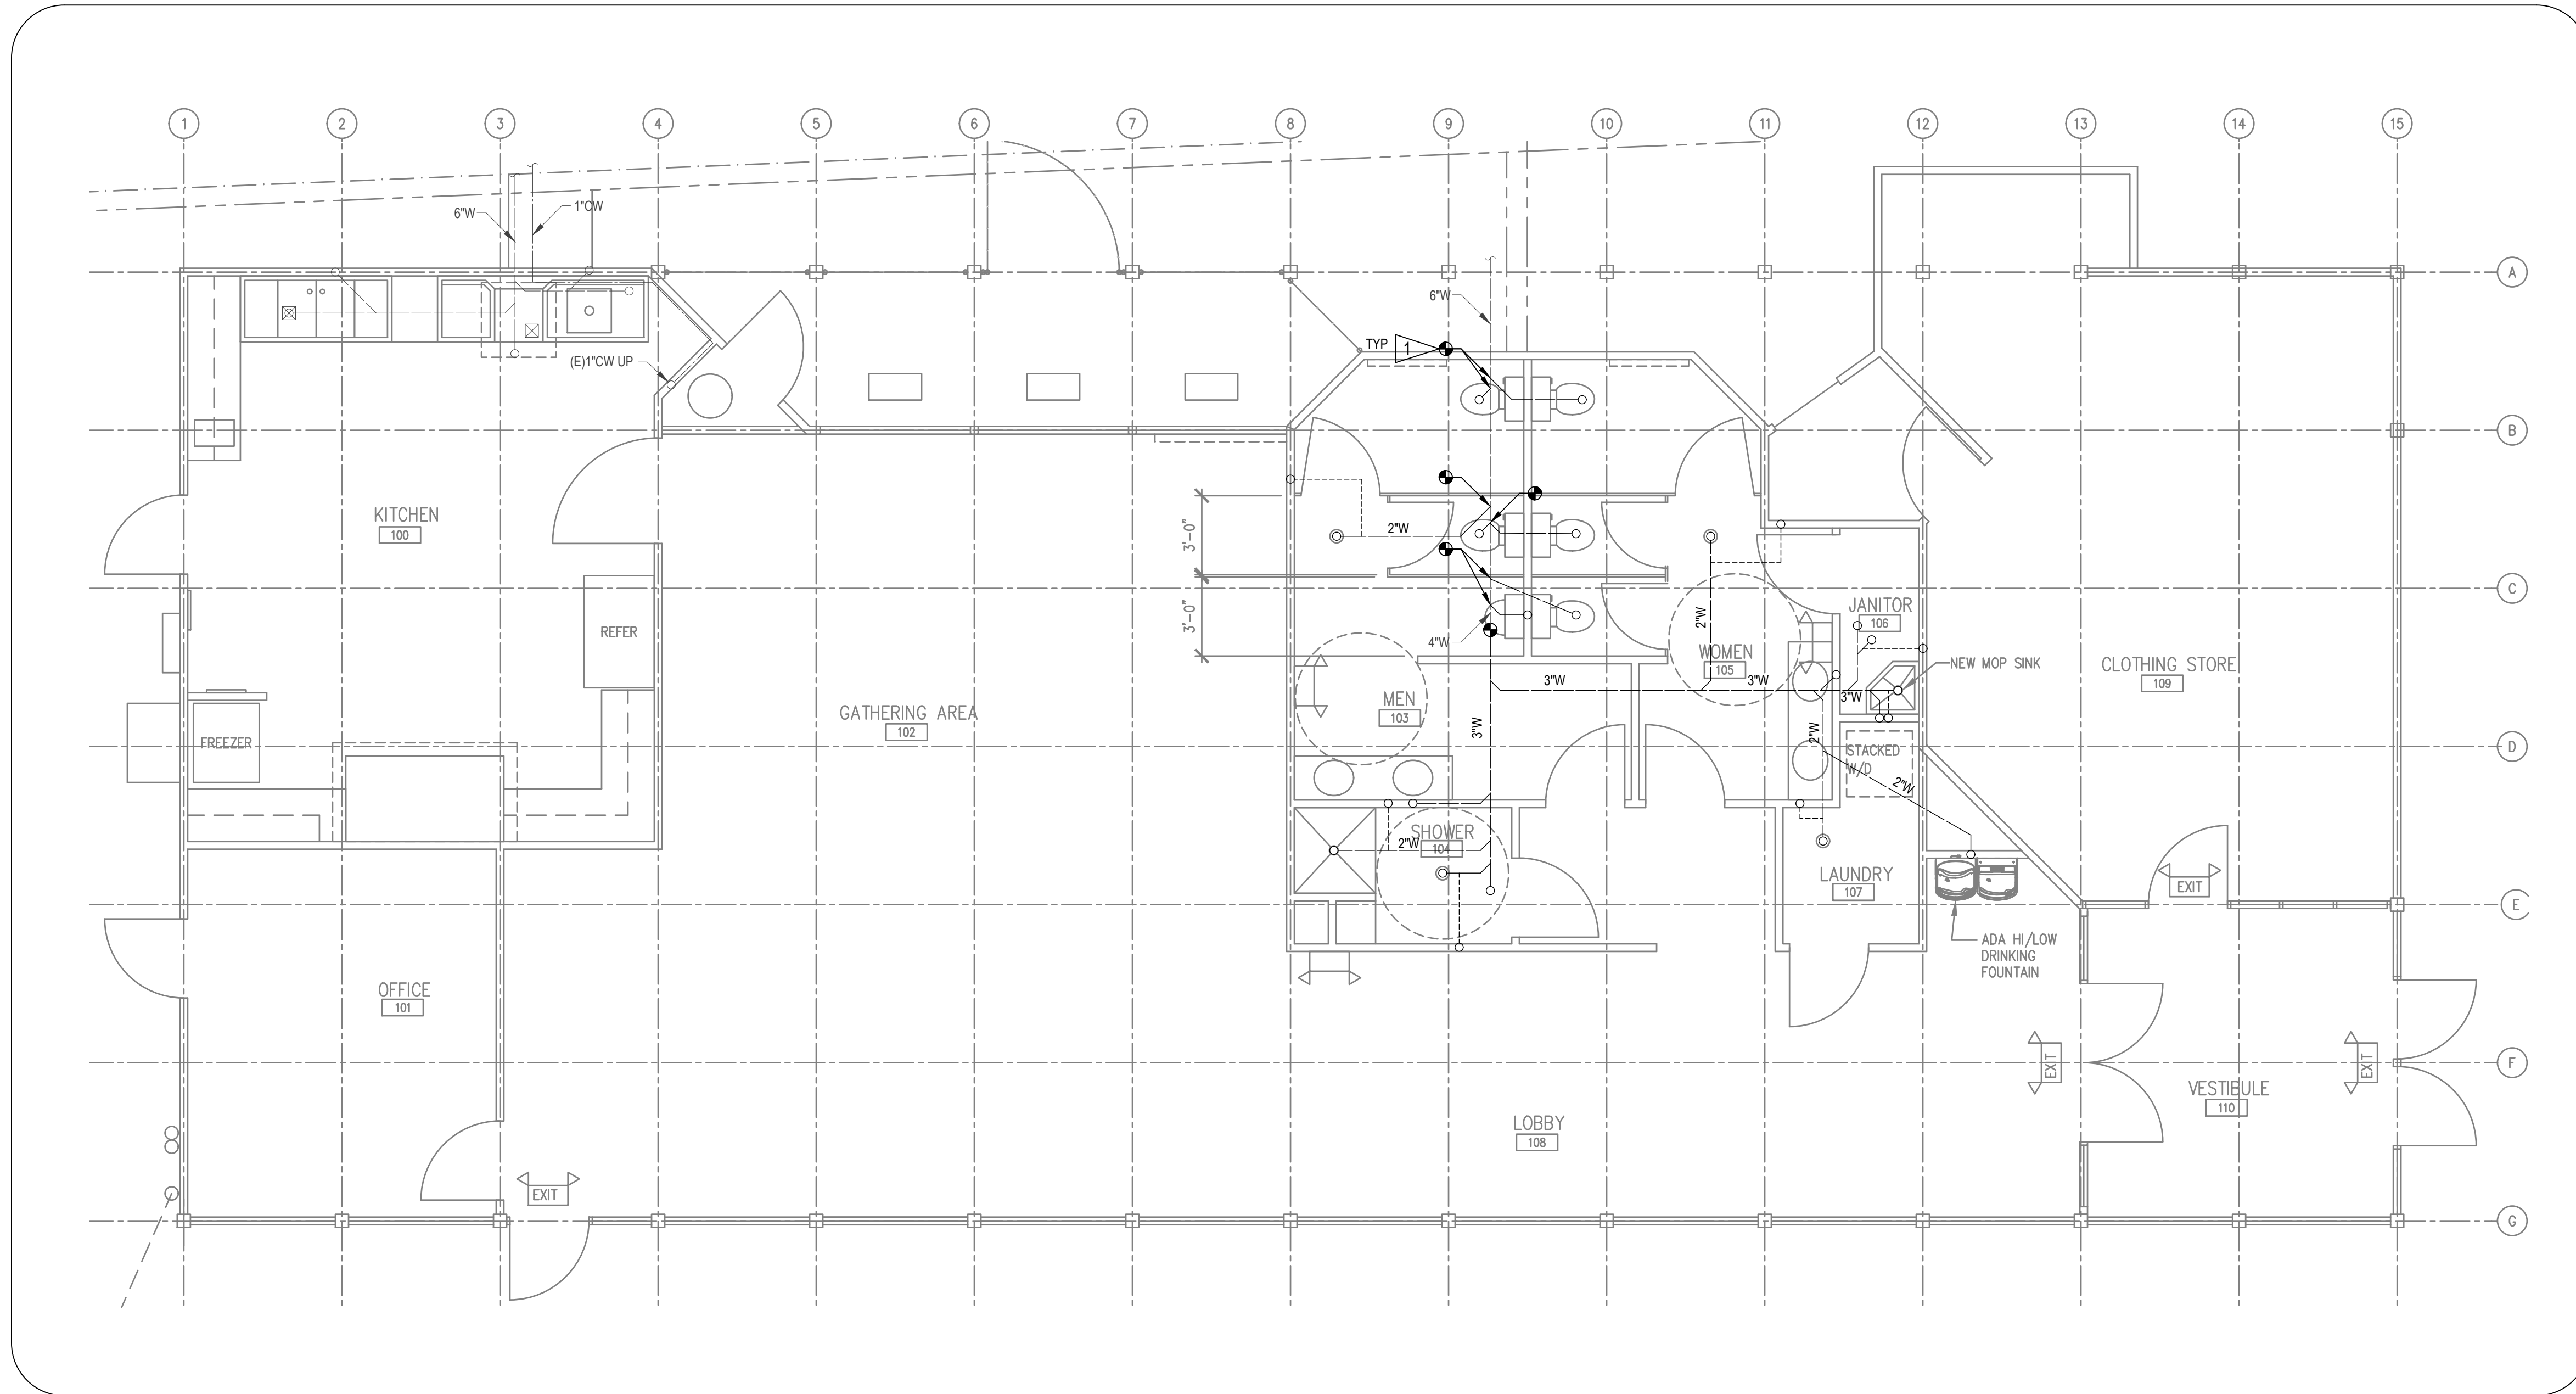


1 UNDERGROUND PLUMBING PLAN
P1.2 SCALE: 1/4" = 1'-0"

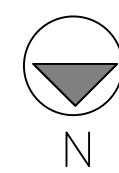

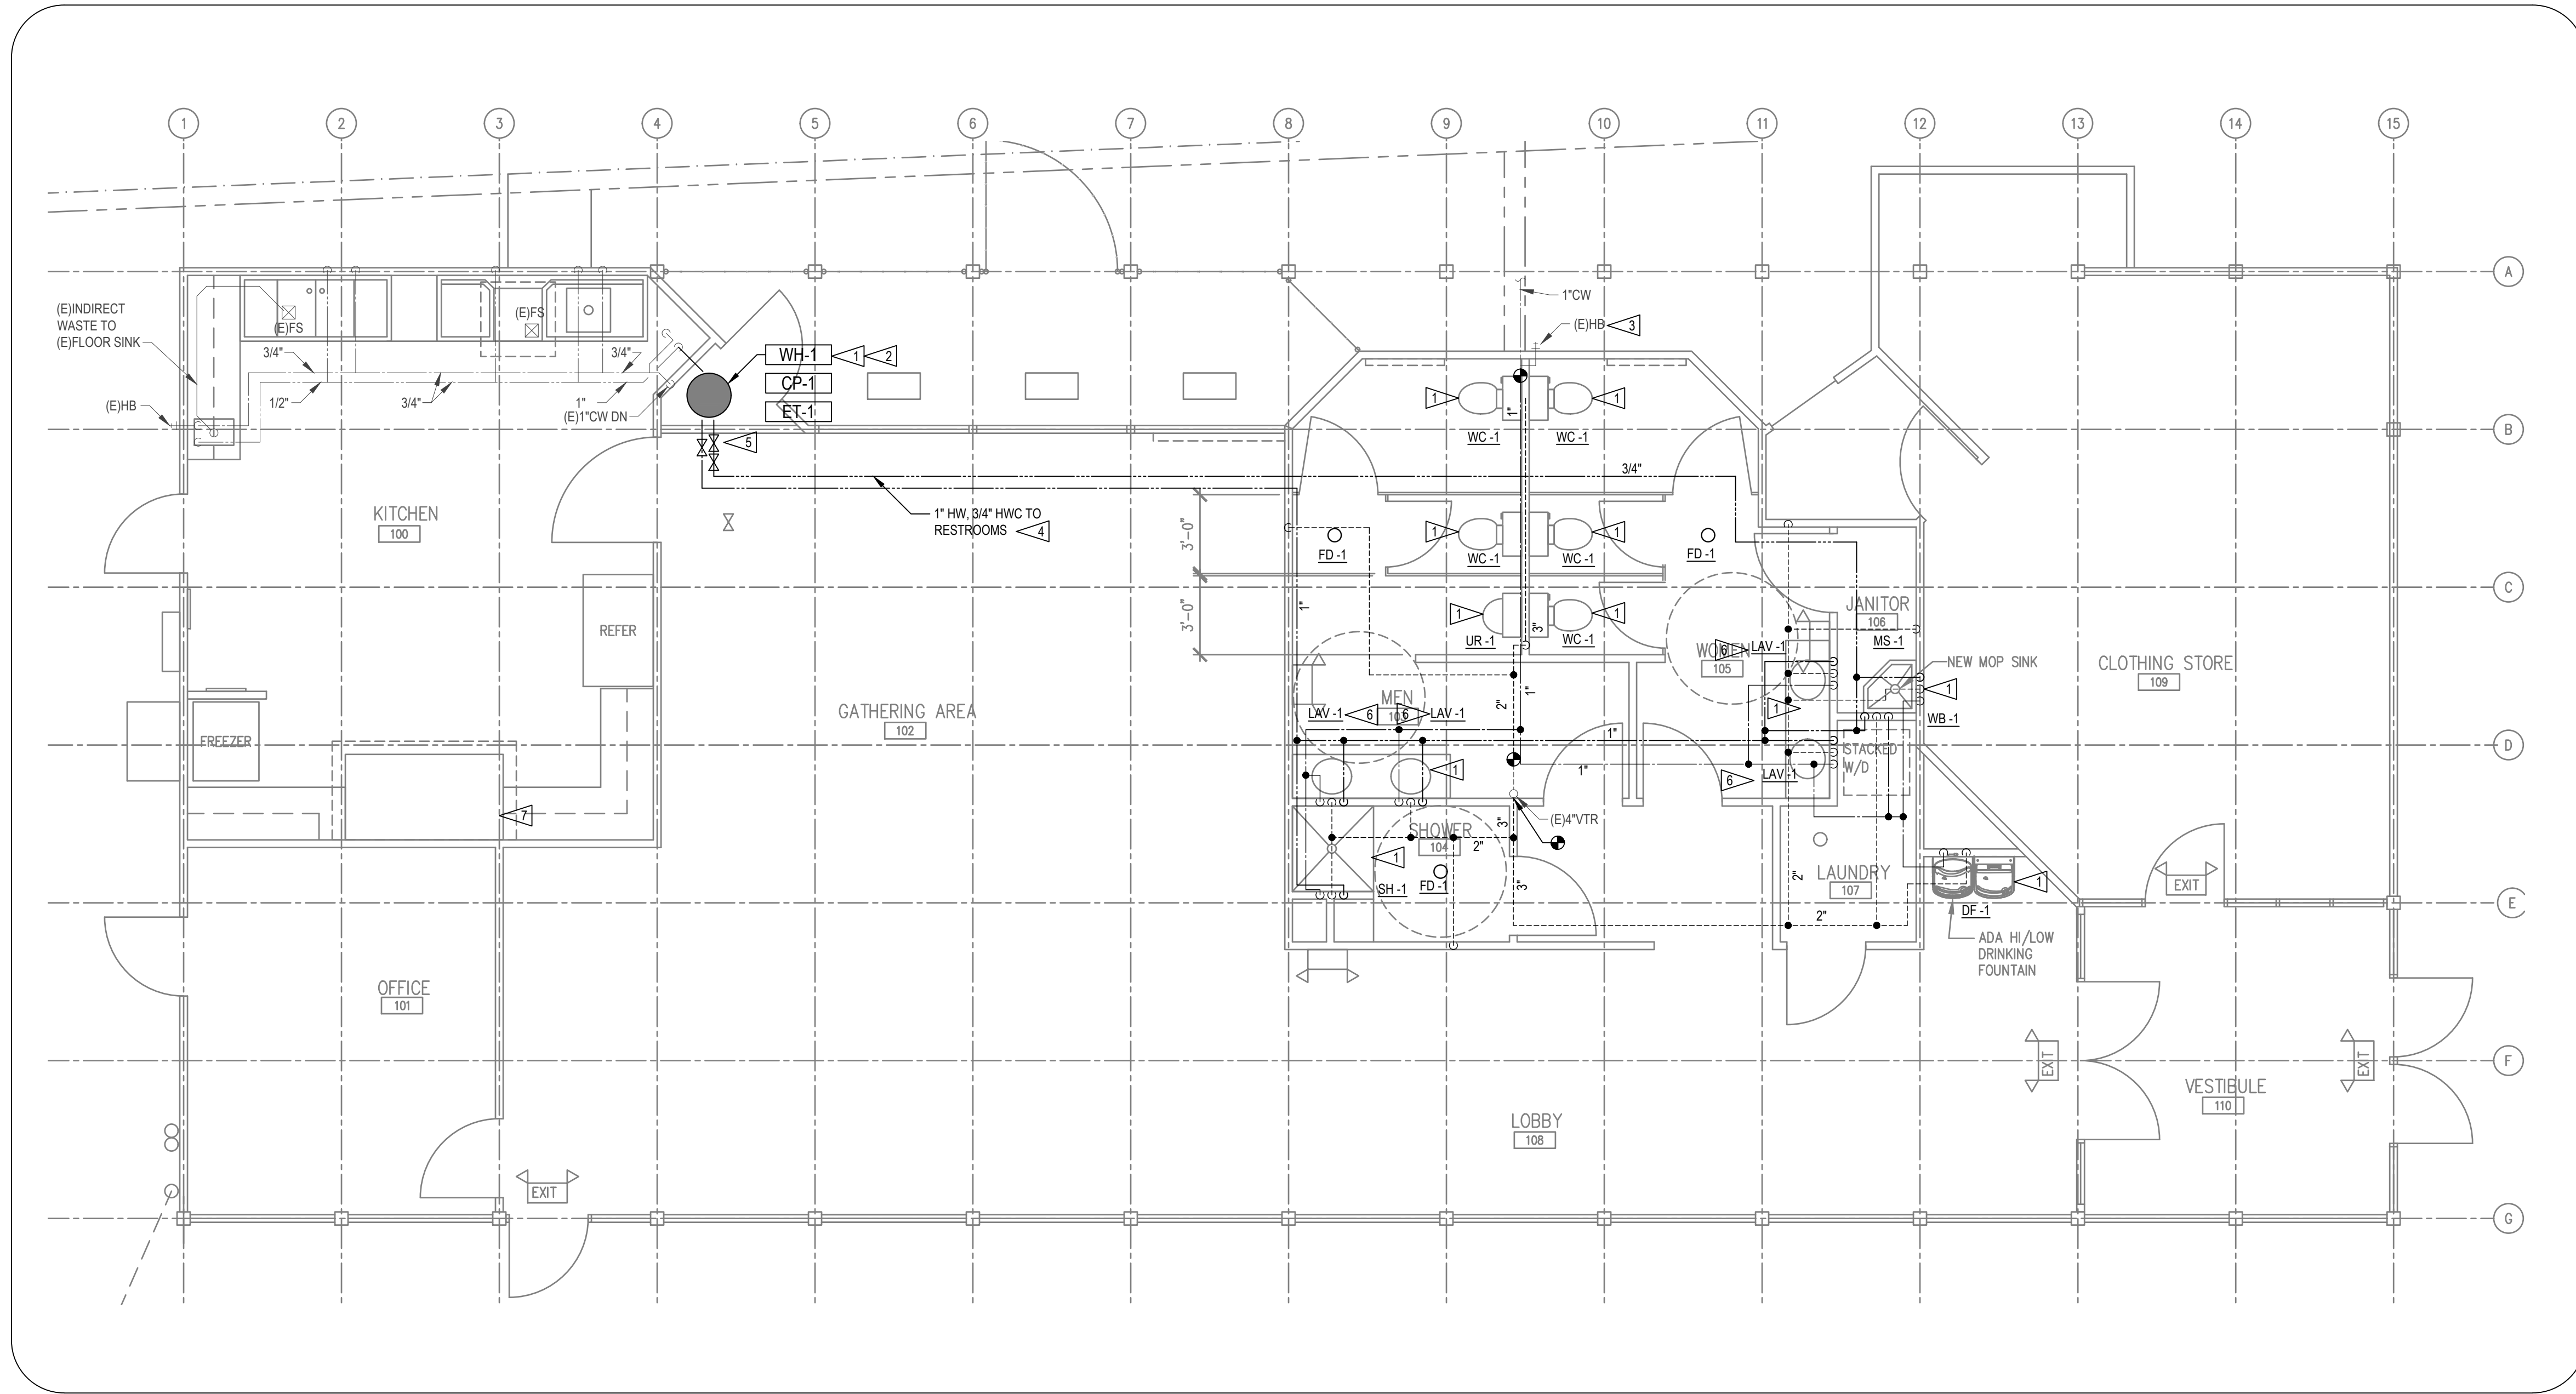

1 FIRST FLOOR PLUMBING PLAN
P1.3 SCALE: 1/4" = 1'-0"

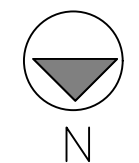

- GENERAL NOTES:**
1. CONTRACTOR SHALL COORDINATE LOCATION OF ALL ACCESS DOORS AND PANELS FOR EQUIPMENT AND ACCESSORIES.
 2. FIELD COORDINATE CONDENSATE DRAIN PIPING ROUTING TO APPROVED DISCHARGE LOCATION.
 3. PROVIDE TRAP PRIMER TO EACH FLOOR DRAIN/FLOOR SINK. FIELD LOCATE.
 4. PROVIDE LINE SIZED ISOLATION VALVES ON ALL BRANCH PIPE TAKE OFFS FOR HW, CW HWC.
 5. REFER TO PLUMBING FIXTURE SCHEDULE FOR FIXTURE BRANCH PIPE SIZES.

- KEYED NOTES:**
- 1 PROVIDE PLUMBING FIXTURE AND CONNECT TO NEW UTILITIES.
 - 2 PROVIDE WATER HEATER AND CONNECT TO EXISTING PIPING AND PROVIDE EXTENSION OF HW AND HWC TO RESTROOMS.
 - 3 PROVIDE CONNECTION TO EXISTING HOSE BIB.
 - 4 ROUTE PIPING TIGHT TO ROOF.
 - 5 PROVIDE CIRCUIT SOLVER DEVICE WITH ISOLATION VALVE ON INLET AND OUTLET.
 - 6 PROVIDE THERMAL MIXING VALVE FOR LAV.
 - 7 PROVIDE GAS SOLENOID VALVE ON EXISTING GAS PIPING TO COOKING APPLIANCES. INTEGRATE VALVE OPERATION WITH ANSUL SYSTEM.




**SKAGIT COUNTY
CONCRETE COMMUNITY
CENTER**

REVISIONS


stage:	BID SET
client:	CARLETTI ARCHITECTS
project:	CONCRETE COMMUNITY CENTER 45821 RAILROAD AVE CONCRETE, WASHINGTON
drawn by:	NH
original sheet size:	24x36
revision:	None
date:	2025.02.18
scale:	

**FIRST FLOOR
PLUMBING
PLAN**


sheet.

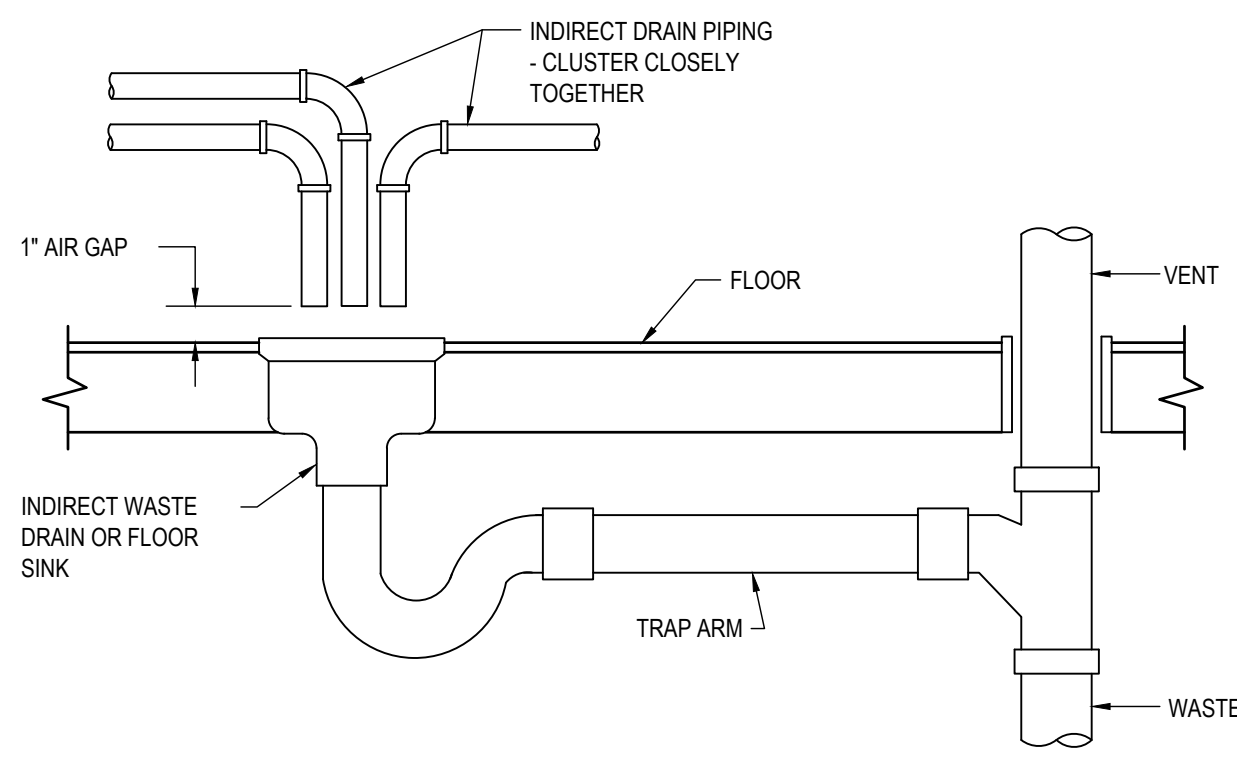

1 INDIRECT WASTE DRAIN DETAIL
N.T.S.

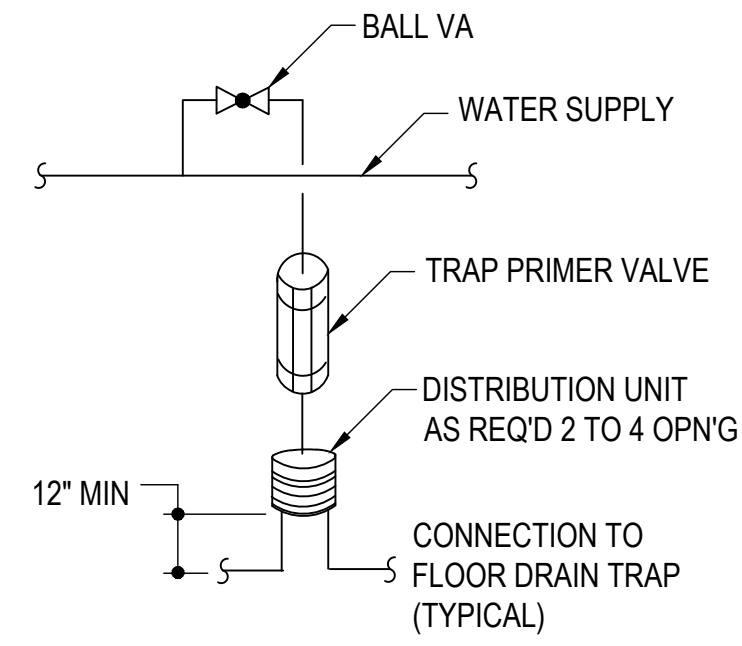


2 TRAP PRIMER DETAIL
N.T.S.

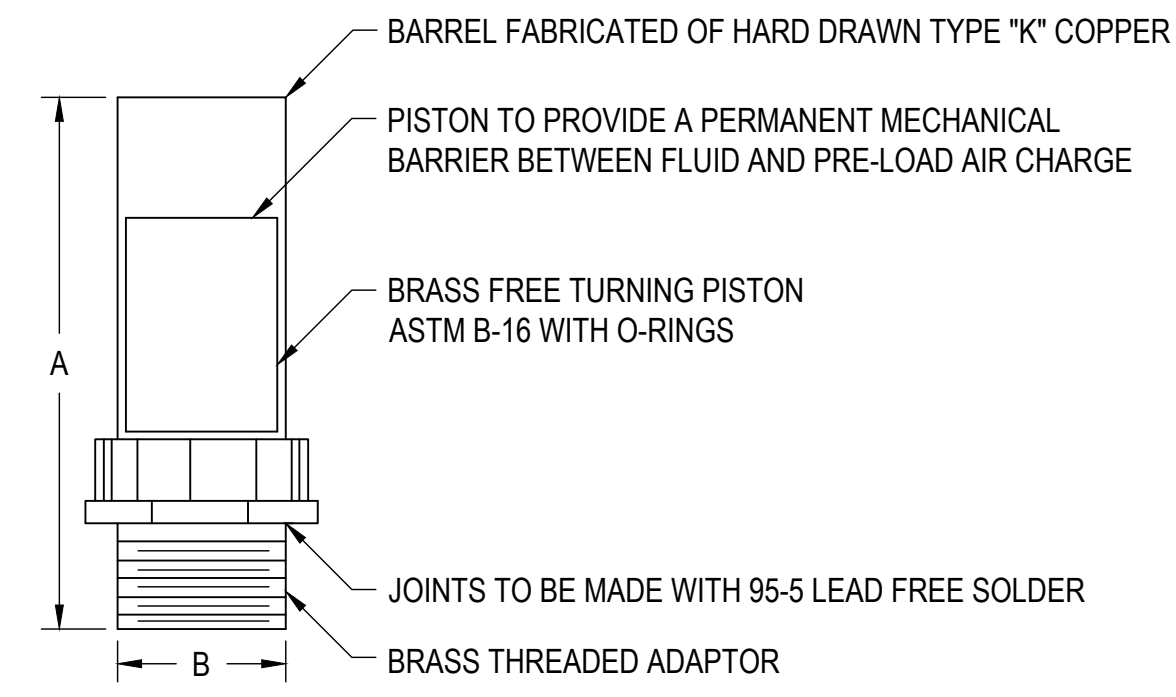


PPP SIZE	P.D.I. SYMBOL	FIXTURE UNIT RATINGS	A SIZE	B SIZE
1/2"	A	1 - 11	5"	1/2"
3/4"	B	12 - 32	5"	3/4"
1"	C	33 - 60	7"	1"
1-1/4"	D	61 - 113	7"	1-1/4"
1-1/2"	E	114 - 154	9"	1-1/2"
2"	F	155 - 330	9"	2"

3 WATER SHOCK ARRESTOR DETAIL
N.T.S.

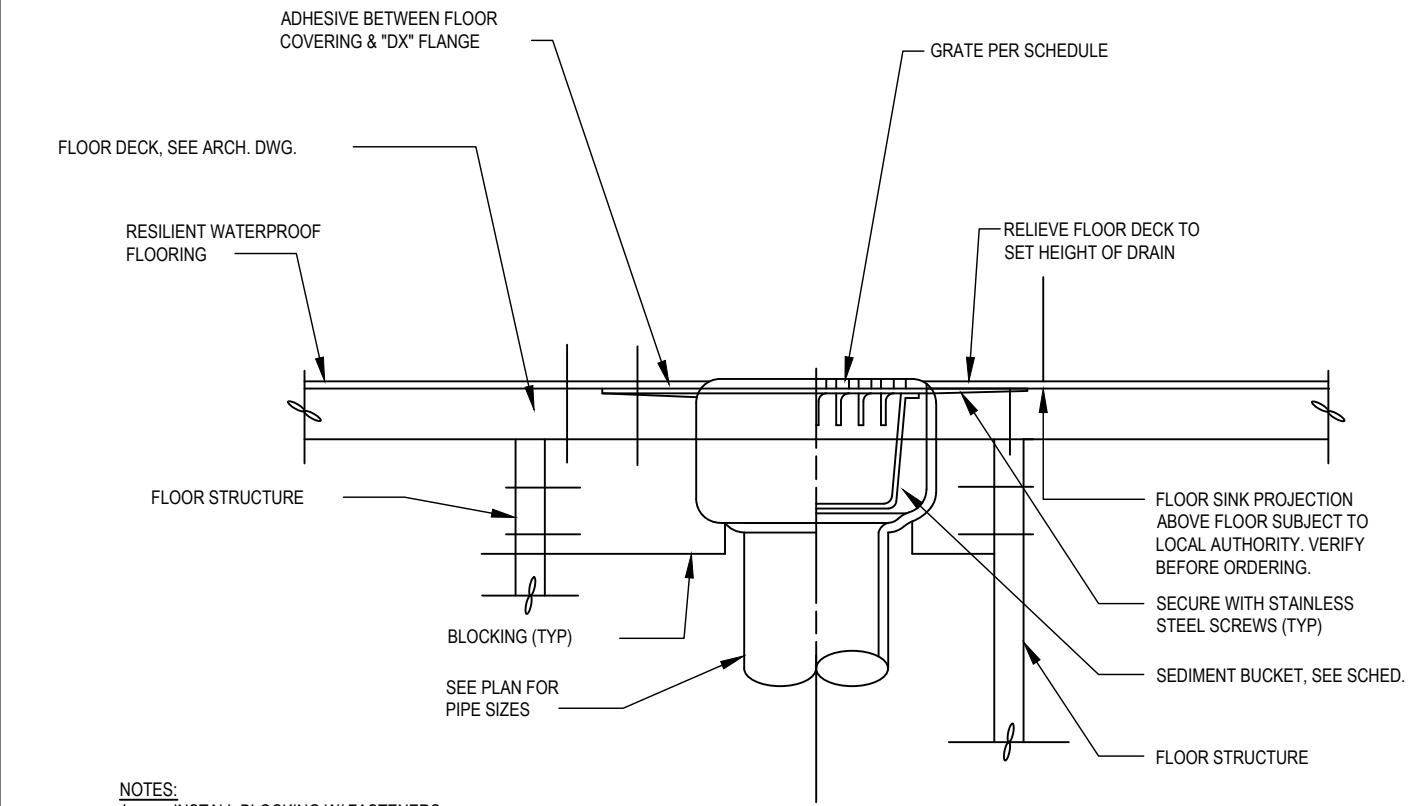


- NOTES:
- INSTALL BLOCKING W/ FASTENERS AND ADHESIVE AFTER DRAIN HEIGHT IS SET.
 - VERIFY ASSEMBLY PROCEDURE W/ FLOORING MFR.
 - INSTALL ONLY 'SL' OR 'DX' STYLE FLOOR DRAINS & FLOOR SINKS FOR WOOD CONST.
 - VERIFY FLOORING CONSTRUCTION BEFORE ORDERING DRAINS.
 - FLOOR DRAINS SHALL BE FLUSH TO 1/4" BELOW FIN. FLOOR. SINKS SHALL BE 1/2" ABOVE TO 1/4" BELOW FIN. FLOOR. VERIFY W/ LOCAL PLUMBING INSPECTOR.
 - PROVIDE TRAP PRIMER CONNECTION.

4 FLOOR DRAIN DETAIL
N.T.S. WOODRAISED FLOOR

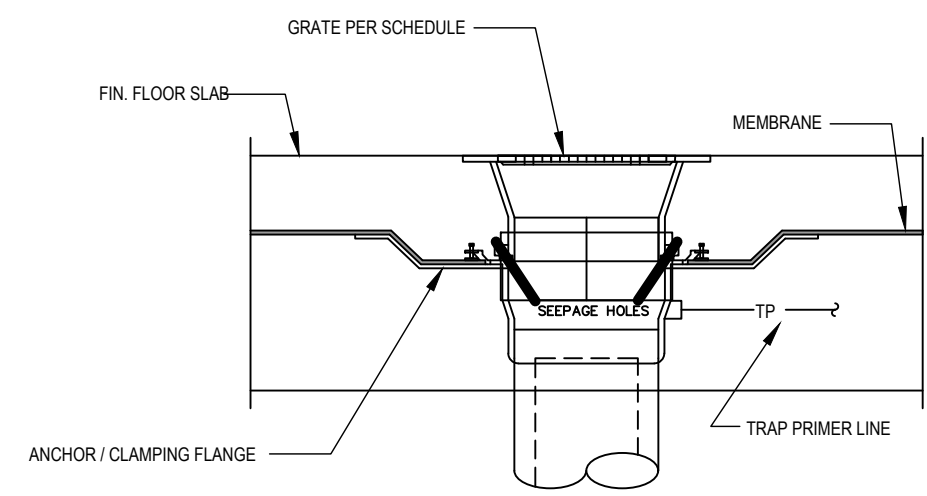


- NOTES:
- VERIFY FLOORING CONSTRUCTION BEFORE ORDERING DRAINS.
 - FLOOR DRAINS SHALL BE FLUSH TO 1/4" BELOW FIN. FLOOR. SINKS SHALL BE 1/2" ABOVE TO 1/4" BELOW FIN. FLOOR. VERIFY W/ LOCAL PLUMBING INSPECTOR.
 - PROVIDE TRAP PRIMER CONNECTION.

5 FLOOR DRAIN DETAIL
N.T.S. CONCRETE FLOOR W/MEMBRANE

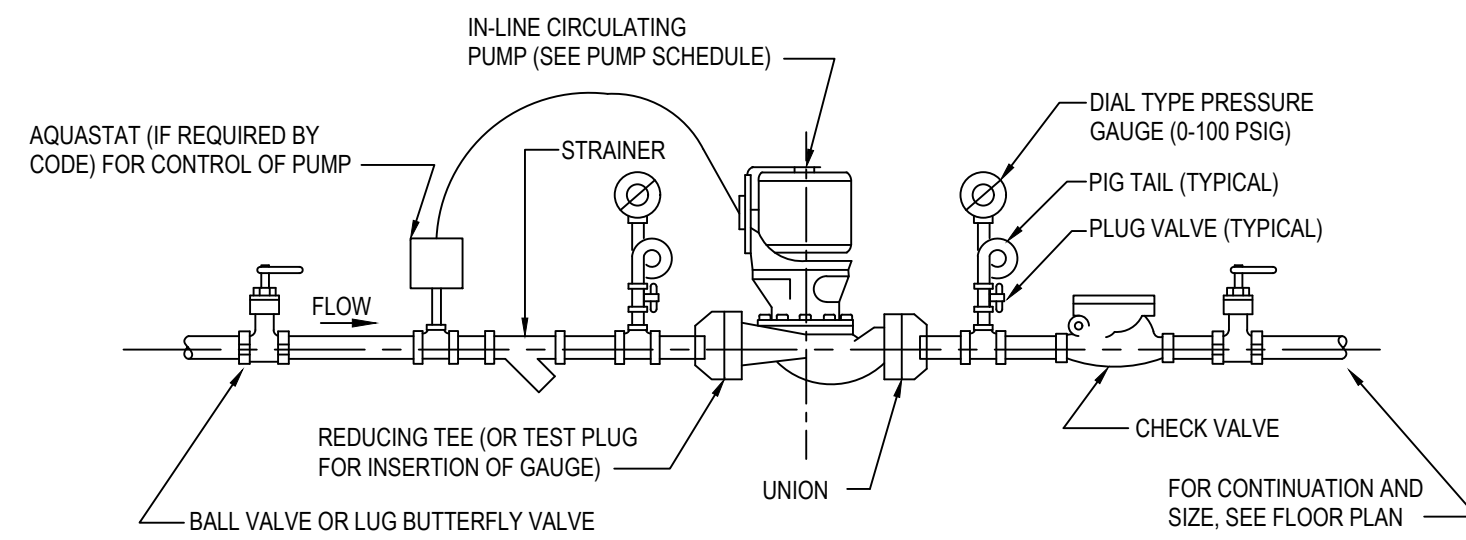


6 IN-LINE CIRCULATING PUMP DETAIL
N.T.S.

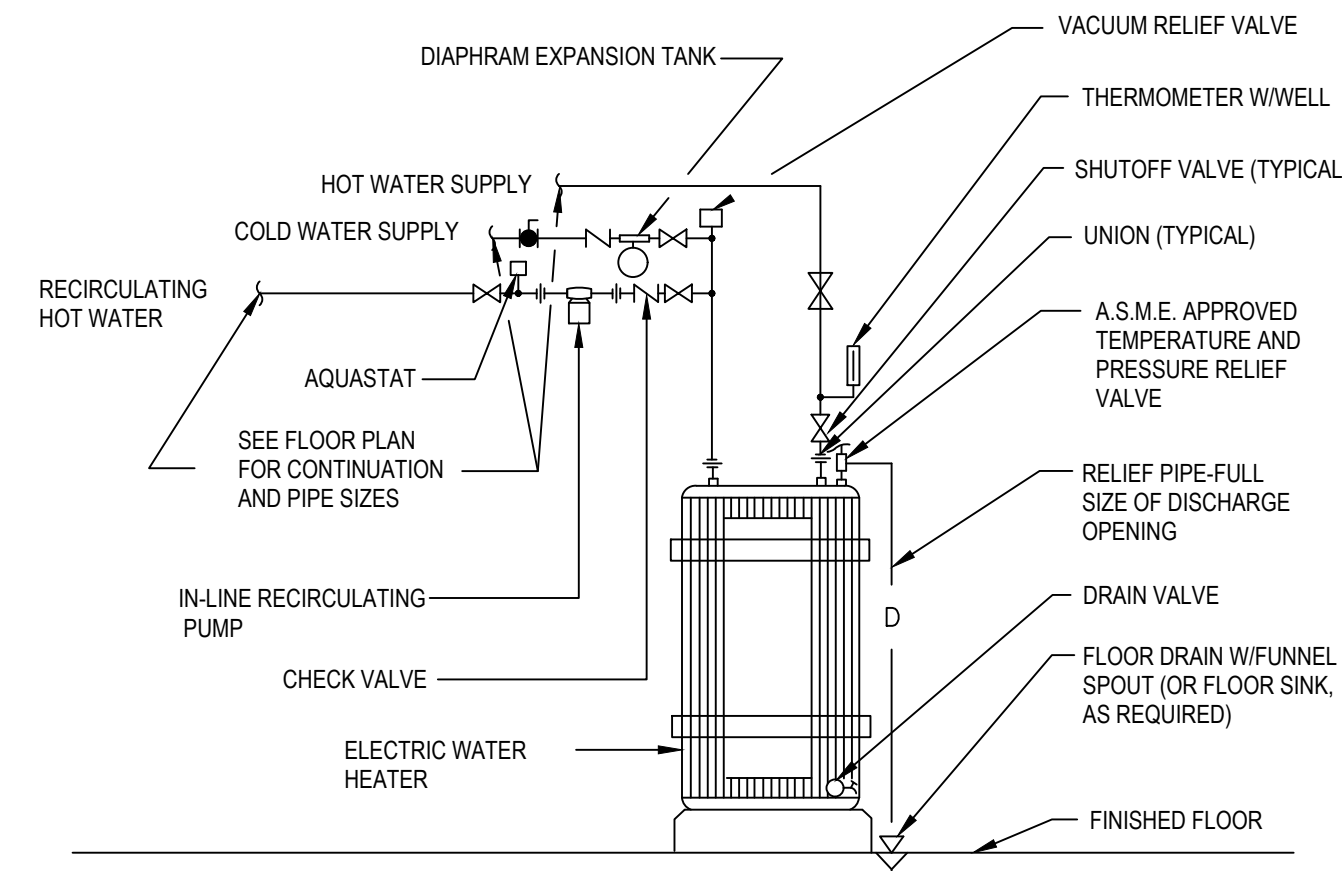

- NOTE:
- ANCHOR WATER HEATER AT UPPER AND LOWER THIRD OF WATER HEATER.
 - PROVIDE R-10 INSULATION BOARD UNDER WATER HEATER PER WSEC.


7 ELECTRIC WATER HEATER DETAIL
N.T.S.

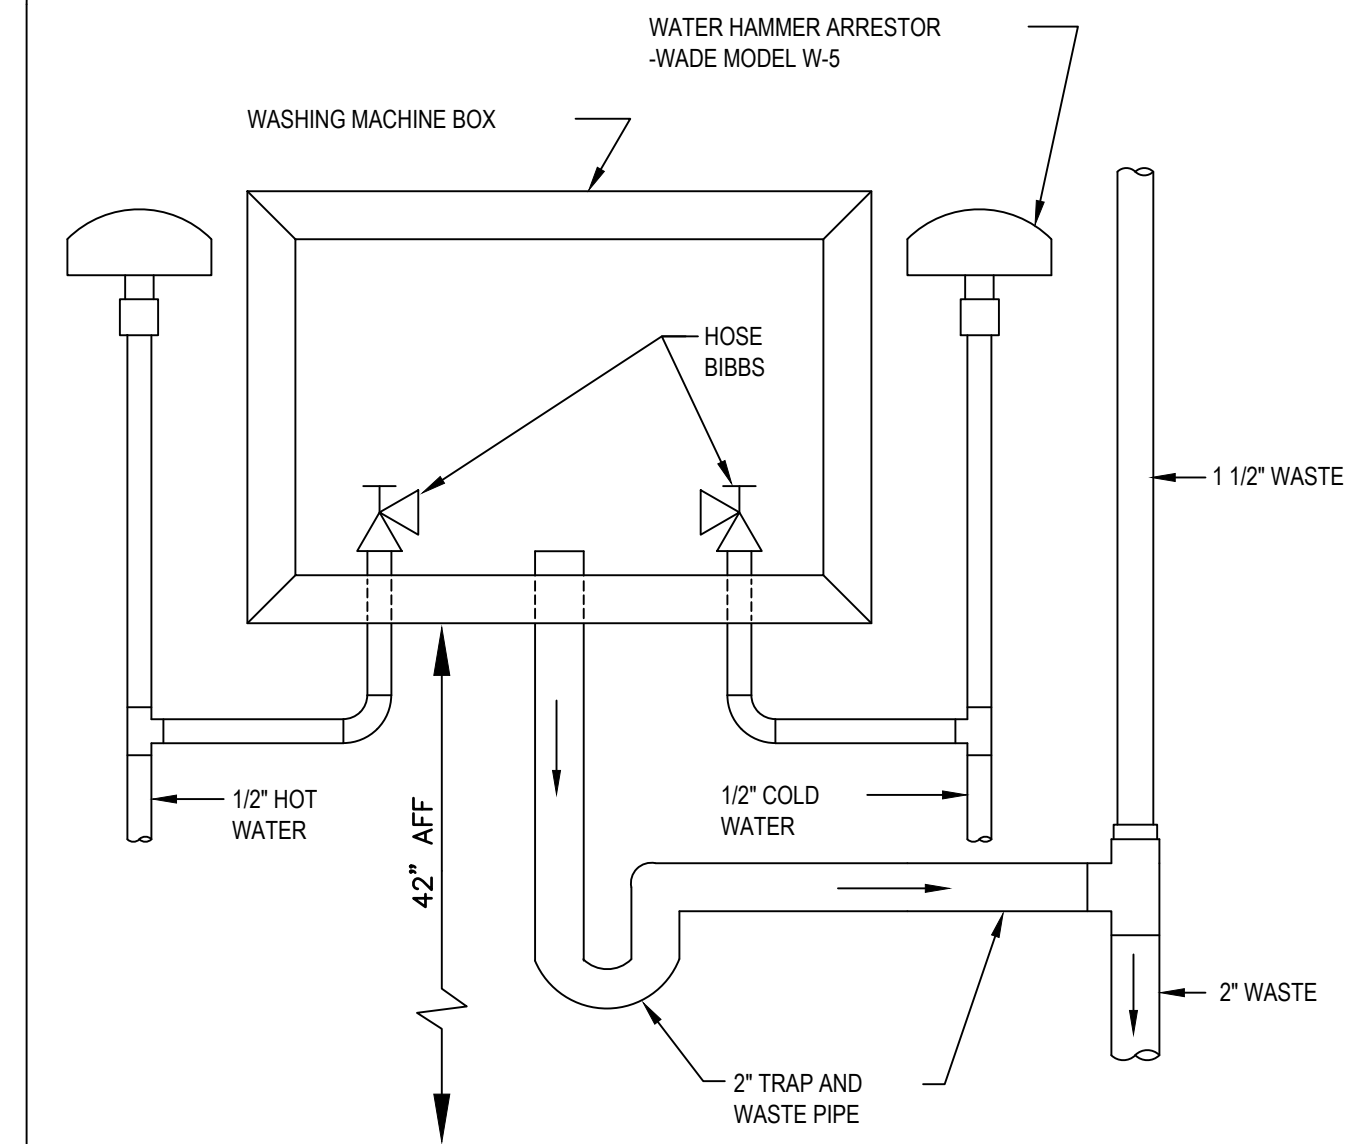

8 WASHING MACHINE BOX DETAIL
N.T.S.



JTK ENGINEERING
HVAC | PLUMBING | ENERGY
WWW.JTKENG.COM

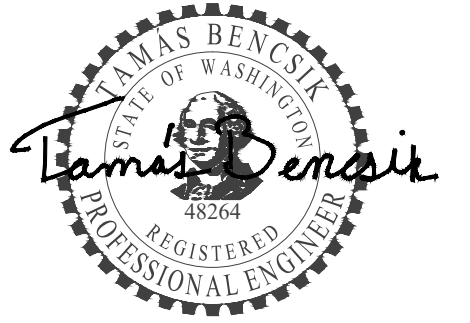

February 15, 2025



CARLETTI ARCHITECTS P.S.
116 EAST FR STREET
SUITE A
MOUNT VERNON, WA 98273
Phone: (360) 434-5384
Fax: (360) 424-3726



**SKAGIT COUNTY
CONCRETE COMMUNITY
CENTER**

REVISIONS

stage: **BID SET**

client: **CARLETTI ARCHITECTS**

project: **CONCRETE COMMUNITY CENTER
45821 RAILROAD AVE
CONCRETE,
WASHINGTON**

drawn by: **NH**

original sheet size: **24x36**

revision: **None**

date: **2025.02.18**

scale:

DETAILS

sheet.

P3.0